

802 EAST COTA STREET, SUITE A SANTA BARBARA, CA 93103 TEL (805) 963-1955

<u>CIVIL ENGINEER</u> BLAIR, CHURCH, & FLYNN 451 Clovis Avenue Clovis, CA 93612 TEL (559) 326-1400


PLUMBING ENGINEER 5000 East Spring Street, Suite 800 Long Beach, CA 90815 TEL (562) 497-2999

<u>MECHANICAL ENGINEER</u> 5000 East Spring Street, Suite 800 Long Beach, CA 90815 TEL (562) 497-2999

5000 East Spring Street, Suite 800 Long Beach, CA 90815

TEL (562) 497-2999

<u>AQUATICS ENGINEER</u> COUNSILMAN-HUNSAKER 12851 Manchester Road, Suite 120 St. Louis, MO 63131 TEL (314) 894-1245

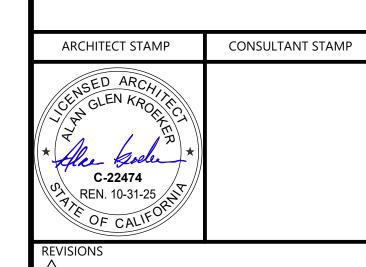

KERN COMMUNITY COLLEGE

1801 Panorama Dr. Bakersfield, CA 93305


Bakersfield College Pool Building and Site Demolition

COVER SHEET

JOB NUMBER: 23024.01

G-000



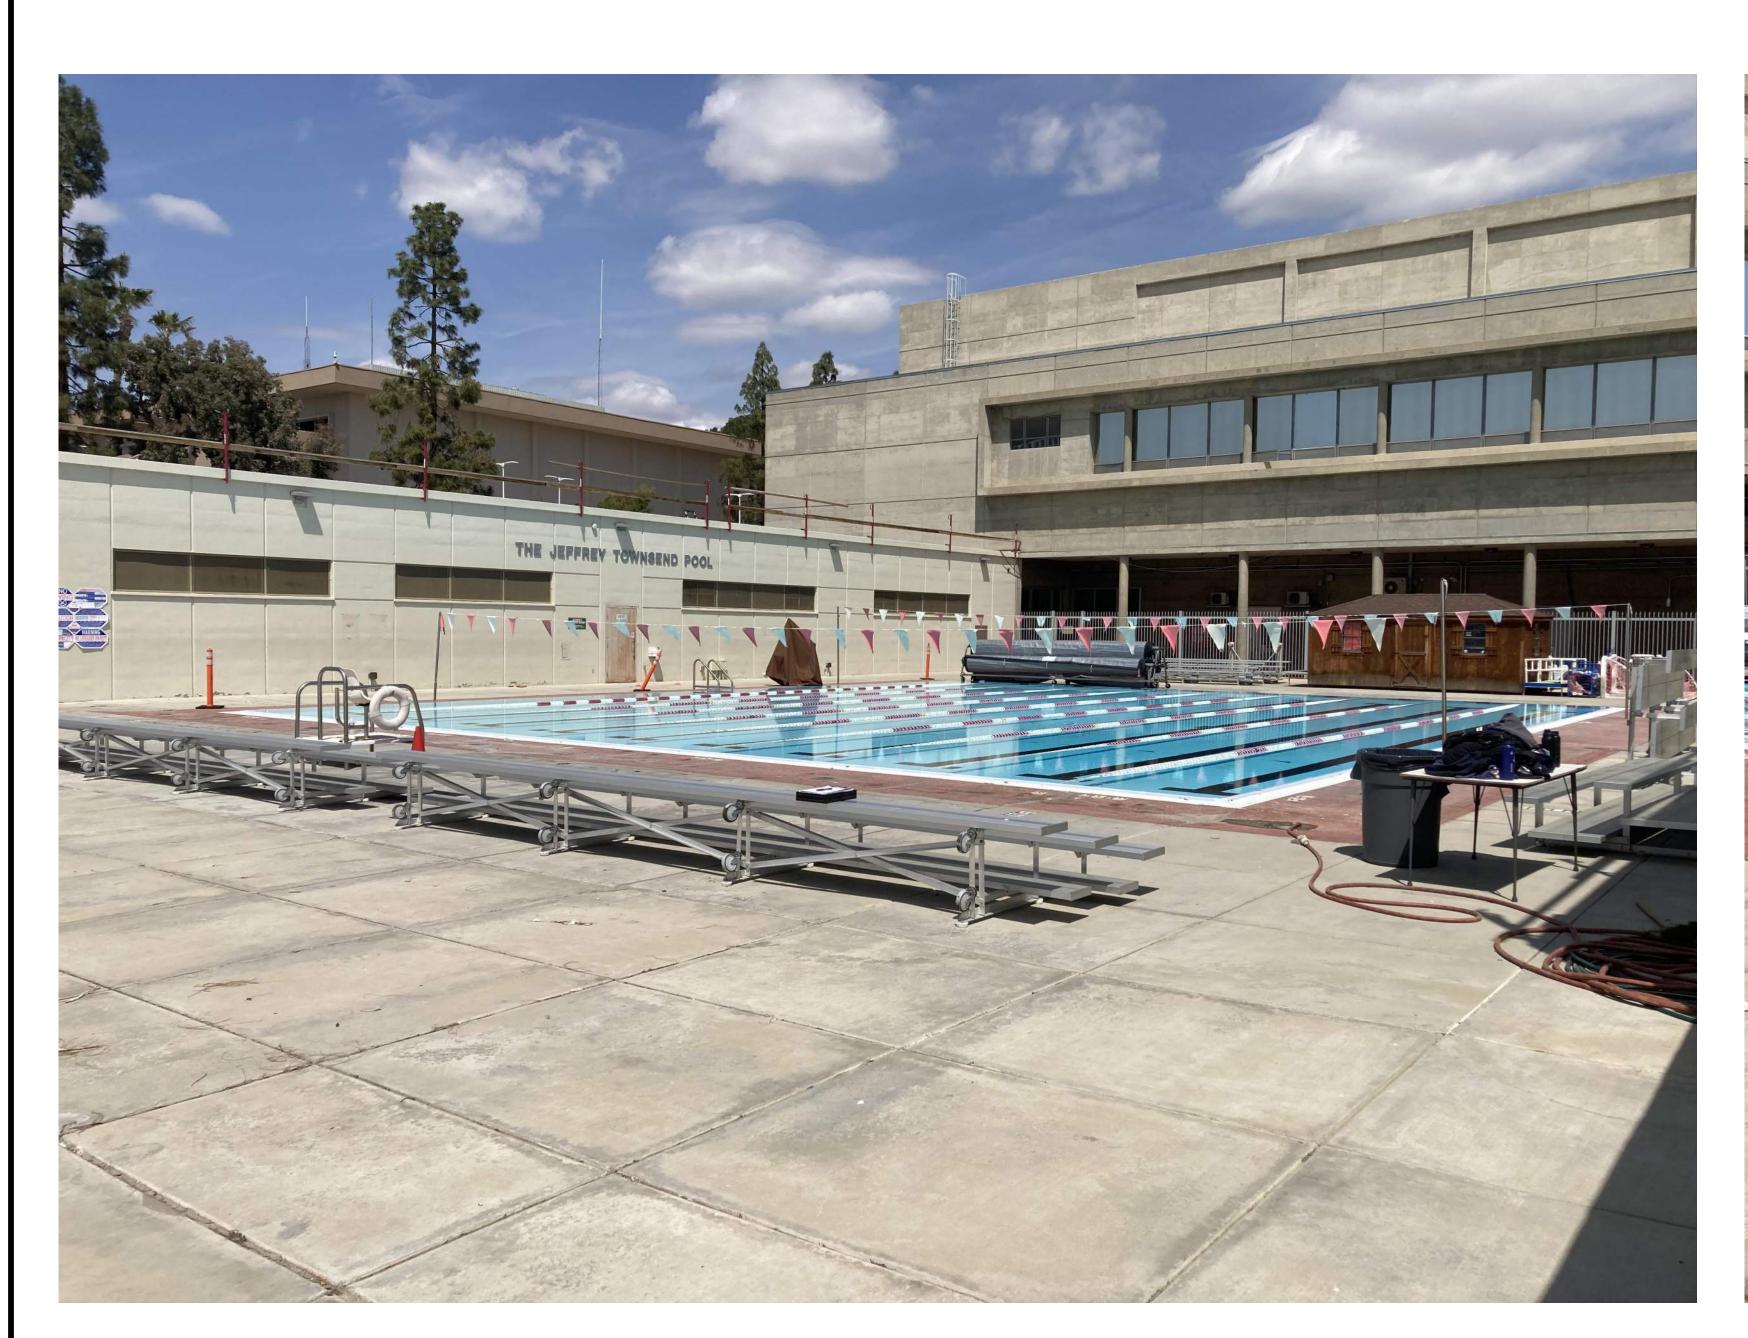



NORTH POOL BUILDING WING


SOUTH POOL BUILDING WING


KERN COMMUNITY COLLEGE DISTRICT Bakersfield College Pool Building and Site Demolition


MARCH 27, 2025 CONSTRUCTION DOCUMENTS

> **FILE NO.15-C1** 03-124690

FILE NO.15-C1 03-124690

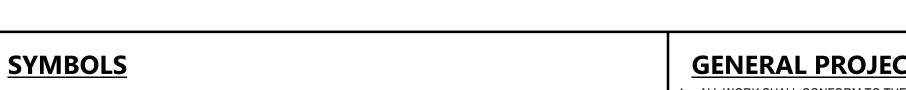

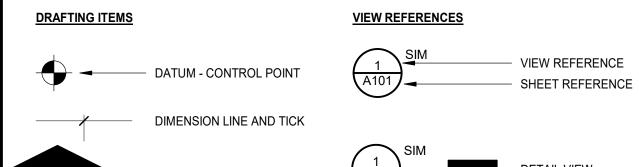

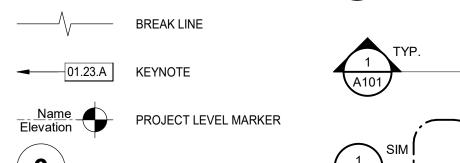

PROJECT NORTH ARROW

MATCHLINE - SEE: 1 / A101

NORTH

ABBREVIATIONS

CENTER LINE

PERPENDICULAR

ANCHOR BOLT

ALTERNATE

APPROXIMATE

ALUMINUM

BUILDING

BLOCK(ING)

CATCH BASIN

CAST IRON

CLEAN OUT

CONCRETE

CONTINUOUS

COUNTERSINK

COLD WATER

DEPARTMENT

DRINKING FOUNTAIN

CHANNEL

DOUBLE

DETAIL

DIAMETER

DIAGONAL

DOWNSPOUT

DRAWING FAST

EXISTING

ELEVATION

EQUIPMENT

FLOW LINE

FLASHING

FLOOR

ELECTRIC(AL)

EDGE OF PAVING

FLOOR DRAIN

FINISHED FLOOR

FACE OF CONCRETE

FACE OF MASONRY

GRAB BAR, GRADE BREAK

GLUE LAMINATED BEAM

GYPSUM WALL BOARD

HEATING/VENTILATING/AIR

FACE OF FINISH

FACE OF STUD

FOOT OR FEET

GALVANIZED

HOSE BIBB

HORIZONTAL

CONDITIONING

HEADER

HEATER

FOOTING

GAUGE

FIRE EXTINGUISHER (& CABINET)

FIBERGLASS REINFORCED PANEL

FLAT HEAD OR FIRE HYDRANT

EXPANSION BOL

EXPANSION JOINT

DOWN

COLUMN

CEILING

CLEAR

BOTTOM OF BEAM

CONSTRUCTION JOINT

CONCRETE MASONRY UNIT

ANOD APPROXIODIZED

ARCH

BLK(G)

BOB

CLR

COL

CONC

CONT

DEPT

DET

FIN

FLR

FOC

FOF

FRP

FTG

GALV

GB

GLB

GYP

HDR

HGT

HORIZ

HTR

GWB

FOM

CSK


CMU

ASPHALTIC CONCRETE

ABOVE FINISH FLOOR

ACOUSTICAL CEILING TILE

ARCHITECT OR ARCHITECTURAL

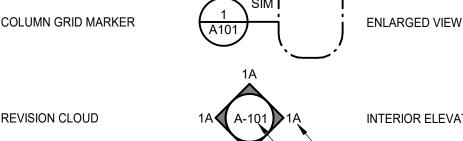

INTERIOR ELEVATION SHEET REFERENCE



INSIDE DIAMETER

LAVATORY

MATERIAL

MAXIMUM

MACHINE BOLT

MISCELLANEOUS

NOT IN CONTRACT

OUTSIDE DIAMETER

PLASTIC LAMINATE

PLATE OR PROPERTY LINE

PLASTER (NUMBER - SEE SPECS)

PRESSURE TREATED DOUGLAS FUR

PAINT (NUMBER - SEE SPECS)

REINFORCE OR REINFORCING

NOT TO SCALE

ON CENTER

PLYWOOD

QUARRY TILE

ROOF DRAIN

REFRIGERATOR

ROUND HEAD

REDWOOD

SCHEDULE

SHEATHING

SMACNA SPECIE ARCH SHEET METAL MANUAL

TOP OF CURB OR TOP OF CONCRETE

TYPICAL (ITEMS TYPICAL UNLESS SHOWN OR

TEMPERATURE OR TEMPERED

UNLESS OTHERWISE NOTED

VERTICAL GRAIN DOUGLAS FIR

VINYL COMPOSITION TILE

WHEELCHAIR ACCESSIBLE

VENT THRU ROOF

WATER CLOSET

WIDE FLANGE

WATERPROOF

WOOD SCREW

WELDED WIRE FABRIC

WAINSCOT

WITHOUT

WATER HEATER

TONGUE & GROOVE

STRUCTURAL TUBING

TOP OF PAVING

TELEVISION

TOP OF WALL

SPECIFICATION

STAINLESS STEEL

STORM DRAIN

SOUTH

SHOWER

SIMII AR

SQUARE

STANDARD

SUSPENDED

SYMMETRICA

T&G

VERT

WSCT

WWF

ROUGH OPENING

MASONRY OPENING

MECHANICAL

MAN HOLE

NUMBER

NO OR #

INSULATION OR INSULATED

MANUFACTURE OR MANUFACTURER

EXTERIOR ELEVATION

GENERAL PROJECT NOTES - COMUNITY COLLEGE

- ALL WORK SHALL CONFORM TO THE BUILDING CODES LISTED IN THESE DOCUMENTS AND ALL CURRENT REVISIONS AND REGULATIONS AS INSTITUTED BY THE AUTHORITY HAVING JURISIDICTION (AHJ).
- THE PROJECT MANUAL AND SPECIFICATIONS IN CONJUNCTION WITH THESE DRAWINGS AND REFERENCES SHALL FORM A PART OF THE CONTRACT AND SHALL BE REFERRED TO AS THE "DOCUMENTS." THE DOCUMENTS DEFINE THE WORK TO BE PERFORMED AS AGREED TO IN THE CONTRACT.
- CHANGES TO APPROVED DRAWINGS AND SPECIFICATIONS SHALL BE MADE BY AN ADDENDUM OR A CHANGE ORDER APPROVED BY THE DIVISION OF THE STATE ARCHITECT AS REQUIRED BY SECTION 4-338, PART 1, TITLE 24, CALIFORNIA CODE OF REGULATIONS
- A DSA CERTIFIED INSPECTOR WITH CLASS 3 SHALL BE EMPLOYED BY THE DISTRICT AND SHALL PROVIDE CONTINUOUS INSPECTION OF THE WORK. THE DUTIES OF THE INSPECTION ARE DEFINED IN SECTION 4-342
- ANY DIFFERENCE BETWEEN THE EXISTING CONSTRUCTION AS OBSERVED IN THE FIELD AND AS SHOWN ON THE DRAWING SHALL BE REPORTED TO THE ARCHITECT BEFORE PROCEEDING WITH THE WORK.
- THE CONTRACTOR SHALL VERIFY ALL DIMENSIONS PRIOR TO STARTING WORK. THE ARCHITECT SHALL BE NOTIFIED OF ANY DISCREPANCIES OR INCONSISTENCIES. THE CONTRACTOR IS RESPONSIBLE FOR CHECKING
- IT SHALL BE THE RESPONSIBILITY OF THE GENERAL CONTRACTOR TO ENSURE THAT ALL APPLICABLE SAFETY
- IT SHALL BE THE RESPONSIBILITY OF THE GENERAL CONTRACTOR TO PROVIDE SUPERVISION OF THE CONSTRUCTION WORK TO ENSURE THAT IT IS BUILT IN CONFORMANCE WITH THE APPROVED PLANS AND SPECIFICATIONS. THE ARCHITECT WILL PROVIDE ONLY PERIODIC OBSERVATION OF THE WORK. SEE NOTE 3 FOR
-). ANY DAMAGE DONE TO THE EXISTING CONSTRUCTION DURING THE COURSE OF THIS WORK SHALL BE REPLACED BY THE CONTRACTOR AT THE CONTRACTOR'S EXPENSE WITH NO ADDITIONAL COST TO THE OWNER. CONSIDERATIONS SHALL COMPLY WITH ALL LOCAL ORDINANCES.
- THE SEISMIC ANCHORAGE OF MECHANICAL AND ELECTRICAL EQUIPMENT SHALL CONFORM TO TITLE 24. CALIFORNIA CODE OF REGULATIONS, CBC SECTION 1616A.1.18 AND ASCE-7 SEC. 13.6. ANCHORAGE DETAILS FOR ROOF/FLOOR MOUNTED EQUIPMENT SHALL BE SHOWN ON PLANS.
- CUTTING, BORING, SAW CUTTING OR DRILLING THROUGH THE NEW OR EXISTING STRUCTURAL ELEMENTS TO BE DONE ONLY WHEN SO DETAILED IN THE DRAWINGS OR ACCEPTED BY THE ARCHITECT AND THE STRUCTURAL ENGINEER WITH THE APPROVAL OF DSA REPRESENTATIVE. ALL WELDING SHALL BE SPECIALLY INSPECTED BY AN AWS-CWI QUALIFIED INSPECTOR APPROVED BY DSA.
- . ALL BRACING OF DUCTS AND PIPES SHALL BE INSTALLED IN ACCORDANCE WITH THE CBC SECTIONS 1617A.1.18 THROUGH 1617A.1.26 AND ASCE 7-16 CHAPTERS 13. 26. AND 30 AS APPROVED BY DSA AND IR 16-13. WHERE BRACING DETAILS ARE NOT SHOWN ON THE DRAWINGS OR IN THE CODE SECTIONS, THE FIELD INSTALLATION SHALL BE SUBJECT TO THE APPROVAL OF THE ARCHITECT, MECHANICAL ENGINEER AND FIELD ENGINEER. A COPY OF THE CODE SECTIONS PUBLISHED BY THE CBC SECTIONS 1617A.1.18 THROUGH 1617A.1.26 AND ASCE 7-16 CHAPTERS 13, 26, AND 30 AND APPROVED BY DSA AND IR 16-13 SHALL BE PROVIDED BY THE CONTRACTOR AND KEPT ON THE JOB AT ALL TIMES.
- . THE INTENT OF THESE DRAWINGS AND SPECIFICATIONS IS THAT THE WORK OF THE ALTERATION, REHABILITATION OR RECONSTRUCTION IS TO BE IN ACCORDANCE WITH TITLE 24, CALIFORNIA CODE OF REGULATIONS. SHOULD ANY EXISTING CONDITIONS SUCH AS DETERIORATION OR NON-COMPLYING CONSTRUCTION BE DISCOVERED WHICH IS NOT COVERED BY THE CONTRACT DOCUMENTS WHEREIN THE FINISHED WORK WILL NOT COMPLY WITH TITLE 24, CALIFORNIA CODE OF REGULATIONS, A CHANGE ORDER, OR A SEPARATE SET OF PLANS AND SPECIFICATIONS, DETAILING AND SPECIFYING THE REQUIRED WORK SHALL BE SUBMITTED TO AND APPROVED BY THE DIVISION OF THE STATE ARCHITECT BEFORE PROCEEDING WITH THE
- 6. A DSA ACCEPTED TESTING LABORATORY DIRECTLY EMPLOYED BY THE DISTRICT SHALL CONDUCT ALL THE
- THE CONTRACTOR AND EACH SUBCONTRACTOR SHALL BE THOROUGHLY FAMILIARIZE WITH THE DOCUMENTS. ALL DISCREPANCIES, CONFLICTS OR OMISSIONS WITHIN THE DOCUMENTS SHALL BE BROUGHT TO THE ATTENTION OF THE ARCHITECT FOR RESOLUTION. FAILURE TO INFORM THE ARCHITECT PRIOR TO THE START OF WORK SHALL CONSTITUTE ACCEPTANCE OF THE DISCREPANCIES, CONFLICTS OR OMISSIONS BY THE CONTRACTOR AND THE WORK SHALL BE COMPLETED AS DEFINED IN THE DOCUMENTS WITHOUT ADDITIONAL COST OR TIME DUE TO THE DISCREPANCIES, CONFLICTS OR OMISSIONS.
- . THE CONTRACTOR AND EACH SUBCONTRACTOR SHALL BE ACQUAINTED WITH THE WORK OF OTHER TRADES WHOSE ACTIVITIES WILL ADJOIN OR BE AFFECTED BY THEIR WORK. THEY SHALL CONSULT WITH THESE OTHER CONTRACTORS OR WORKERS AND STUDY THEIR SHOP DRAWINGS IN ORDER TO COORDINATE THEIR EFFORT TOWARD AVOIDING MISTAKES, OMISSIONS, DISPUTES OR DELAYS.
- . THE CONTRACTOR SHALL SUPERVISE AND DIRECT THE WORK AND SHALL BE SOLELY RESPONSIBLE FOR ALL CONSTRUCTION MEANS, METHODS, TECHNIQUES, SEQUENCES AND PROCEDURES. OBSERVATION VISITS TO THE SITE BY THE ARCHITECT AND CONSULTANTS SHALL NOT INCLUDE INSPECTIONS OF THE MEANS, METHODS, TECHNIQUES, SEQUENCES, OR PROCEDURE'S REQUIRED, WHICH ARE THE SOLE RESPONSIBILITY OF THE
- . THE CONTRACTOR AND EACH SUBCONTRACTOR SHALL REVIEW STRUCTURAL, MECHANICAL (HVAC), PLUMBING ELECTRICAL, AND INTERIOR DRAWINGS FOR CURBS, PADS, WALL OPENINGS, BLOCKING IN WALLS, CEILING OPENINGS AND ROOF OPENINGS FOR SIZE, LOCATION AND APPLICABLE DETAILS. VERIFY FINAL ITEMS WITH SELECTED SUPPLIERS. ALL SUCH WORK IS A PART OF THE WORK.
- . ALL DIMENSIONS SHOWN ARE TAKEN TO CENTERLINE OF COLUMNS, GRID LINES, THE FACE OF STUD, FACE OF MASONRY OR FACE OF CONCRETE UNLESS NOTED OTHERWISE. VERIFY ALL DIMENSIONS AT THE SITE. 22. DO NOT SCALE DRAWINGS, DIMENSIONS SHOWN SHALL TAKE PRECEDENCE OVER DRAWING SCALE.
- I. REFERENCE TO ANY PARTICULAR DETAIL OR DRAWINGS IS FOR CONVENIENCE ONLY AND DOES NOT LIMIT THE APPLICATION OF SUCH DETAIL OR DRAWING. NOTES AND DETAILS SHALL APPLY TO ALL DRAWINGS UNLESS
- . THE CONTRACTOR AND EACH SUBCONTRACTOR SHALL MAKE FIELD MEASUREMENTS NECESSARY FOR THIS
- THE WORK BEFORE AND DURING CONSTRUCTION. i. THE CONTRACTOR SHALL PROVIDE, INSTALL AND MAINTAIN ALL PROTECTIVE WALLS, FENCES AND BARRIERS TO SAFEGUARD THE PUBLIC FROM THE CONSTRUCTION WORK FOR THE ENTIRE TIME THE CONSTRUCTION IS IN

WORK, AND BE RESPONSIBLE FOR THEIR ACCURACY. VERIFY ALL DIMENSIONS, GRADES AND CONDITIONS OF

6. THE LOCATION OF ALL STAGING, PARKING, LOADING AND STORAGE OF MATERIALS, EQUIPMENT AND

. THE CONTRACTOR SHALL DETERMINE LOCATION OF UTILITY SERVICES IN THE AREA OF WORK PRIOR TO

- EMPLOYEES ON THE SITE SHALL BE VERIFIED WITH AND APPROVED IN WRITING BY THE OWNER.
- 8. NO PIPES, DUCTS, SLEEVES, CHASES OR CONDUIT SHALL BE PLACED IN CONCRETE SLABS, CONCRETE BEAM OR CONCRETE BLOCK WALLS UNLESS SPECIFICALLY SHOWN OR NOTED OTHERWISE.

30. STRUCTURAL MEMBERS SHALL NOT BE CUT FOR PIPES, DUCTS, SLEEVES, CHASES OR CONDUIT UNLESS

- 9 . ALL PIPING, CONDUIT AND DUCTWORK SHALL BE INSTALLED AS HIGH AS POSSIBLE, TIGHT TO THE UNDERSIDE OF THE STRUCTURE ABOVE CEILINGS, WITHIN WALLS OR IN CONCEALED SPACES UNLESS NOTED OTHERWISE.
- 1. IF ASBESTOS IS ENCOUNTERED, INFORM OWNER IMMEDIATELY.
- l. FACILITIES: THE CONTRACTOR SHALL PROVIDE AND MAINTAIN TEMPORARY SANITARY TOILET FACILITIES ON SIT FOR THE ENTIRE TIME THAT CONSTRUCTION IS IN PROGRESS.
- i. THE CONTRACTOR SHALL MAINTAIN THE SITE, BUILDING(S) AND ADJACENT STREETS CLEAN AND FREE OF ACCUMULATION OF CONSTRUCTION DEBRIS.
- 34. MINIMUM R VALUES UNLESS OTHERWISE NOTED a. WALLS – R19 CEILINGS – R19 ROOF –R30

SPECIFICALLY SHOWN OR NOTED.

5. EMERGENCY VEHICLE ACCESS ROADS AND ON-SITE FIRE HYDRANTS SHALL BE IN SERVICE AND OPERABLE PRIOR TO LOADING THE SITE WITH COMBUSTIBLE MATERIALS.

PROJECT DESCRIPTION

THE PROPOSED PROJECT CONSISTS OF THE ENTIRE DEMOLITION OF THE EXISITING ONE-STORY POOL BUILDINGS ON THE NORTH AND SOUTH SIDE OF EXISTING WARM-UP POOL. THE EXISTING BASEMENT UNDERNEATH THE SOUTH POOL BUILDING IS TO REMAIN AND WILL BE BACKFILLED. ALL EXISTING POOL EQUIPMENT IN THE BASEMENT IS TO BE REMOVED AND STORED FOR RELOCATION.

THE PROJECT ALSO INCLUDES SITE IMPROVEMENTS TO THE EXISTING POOL DECK AREA. SITE IMPROVEMENTS INCLUDE DEMOLITION OF UNDERGROUND UTILITIES RELATED TO THE DEMOLISHED BUILDINGS. DEMOLITION OF THE CONCRETE FLATWORK, DEMOLITION OF THE CONCRETE POOL DECK AT WARM-UP POOL, DEMOLITION OF THE FENCE AND GATES, AND THE PREPARATION OF STUB OUTS FOR FUTURE DEVELOPMENT OF THE SITE.

SHEET INDEX

1. OVERALL GENERAL INFORMATION G-000 COVER SHEET G-001 TITLE SHEET G-101 CODE SITE PLAN G-102 SIGNAGE DETAILS

GENERAL SHEETS TOTAL: 4

2. CIVIL ENGINEERING TOPOGRAPHIC SURVEY LEGEND AND NOTES TOPOGRAPHIC SURVEY

C-200 DEMOLITION PLAN CIVIL SHEETS TOTAL: 3 4. ARCHITECTURAL DRAWINGS DEMOLITION SITE PLAN

ENLARGED DEMOLITION SITE PLAN A-021 DEMOLITION FLOOR PLAN A-022 DEMOLITION FLOOR PLANS DEMO REFLECTED CEILING PLANS A-024 DEMOLITION ROOF PLANS **DEMOLITION EXTERIOR ELEVATIONS** DEMOLITION EXTERIOR ELEVATIONS A-041 DEMOLITION SECTIONS

ARCHITECTURAL SHEETS TOTAL: 9

P-022

GENERAL NOTES, LEGEND, ABBREVIATIONS AND SHEET INDEX **ENLARGED SITE PLAN** BASEMENT DEMOLITION PLAN

8. ELECTRICAL ENGINEERING GENERAL NOTES, LEGEND, ABBREVIATIONS AND SHEET INDEX

E-012 ENLARGED SITE PLAN E-021 BASEMENT DEMOLITION PLAN E-022 DEMOLITION FLOOR PLANS ELECTRICAL SHEETS TOTAL: 4

DEMOLITION FLOOR PLANS

10. AQUATICS ENGINEERING POOL REFERENCE PLAN AQ-100 POOL SITE DEMOLITION PLAN AQ-101 POOL MECHANICAL ROOM DEMO. PLAN AQUATICS TOTAL: 3 **OVERALL SHEET TOTAL: 27**

National Flood Hazard Layer FIRMette

Digital Data Available

MAP PANELS Unmapped

No Digital Data Available

APPLICABLE CODES AND STANDARDS

ALL PARTS OF THE TITLE 24 CODE SHOWN BELOW HAVE AN EFFECTIVE DATE OF JANUARY 1, 2023 EXCEPT: CALIFORNIA ADMINISTRATIVE CODE - EFFECTIVE MARCH 5, 2022

California Administrative Code (CAC) - CCR, TITLE 24, Part 1 California Building Code (CBC) - CCR, TITLE 24, Part 2 California Electrical Code (CEC) - CCR, TITLE 24, Part 3

California Plumbing Code (CPC) - CCR, TITLE 24, Part 5 (2021 IAPMO Uniform Plumbing Code and 2022 California Amendments)

California Fire Code (CFC) - CCR, TITLE 24, Part 9 (2021 International Fire Code and 2022 California Amendments) California Existing Building Code (CEBC) - CCR, TITLE 24, Part 10 California Green Building Standards Code (CALGreen) - CCR, TITLE 24, Part 11

California Referenced Standards Code - CCR, TITLE 24, Part 12

(Public Safety, State Fire Marshal Regulations)

35 AND CALIFORNIA FIRE CODE CHAPTER 80. SEE CALIFORNIA BUILDING CODE CHAPTER 35 FOR STATE OF CALIFORNIA AMENDMENTS TO THE NFPA STANDARDS.

NFPA 12-15 - STANDARD ON CARBON DIOXIDE EXTINGUISHING SYSTEMS NFPA 12A-18 - STANDARD ON HALON 1301 FIRE EXTINGUISHING SYSTEMS NFPA 13 - Standard for the Installation of Sprinkler Systems (AS AMENDED) NFPA 14-19 - Standard for the Installation of Standpipe and Hose Systems NFPA 17-21 - STANDARD FOR DRY CHEMICAL EXTINGUISHING SYSTEMS

NFPA 72-22 - National Fire Alarm and Signaling Code (aS AMENDED)

ICC 300-17 - Standard for Bleachers, Folding and Telescopic Seating, and Grandstands UL 300-2005(r2010) - Standard for Fire Testing of Fire Extinguishing Systems for Protection of Commercial Cooking Equipment

UL 464-03 - Audible Signaling Devices for Fire Alarm and Signaling Systems, Including

(2021 International Building Code, Vol. 1 & 2, and 2022 California amendments) (2021 National Electrical Code and 2022 California Amendments) California Mechanical Code (CMC) - CCR, TITLE 24, Part 4 (2021 IAPMO Uniform Mechanical Code and 2022 California Amendments)

California Energy Code (CEC) - CCR, TITLE 24, Part 6

PARTIAL LIST OF APPLICABLE STANDARDS AS OF JANUARY 1, 2023*

FOR A COMPLETE LIST OF APPLICABLE NFPA STANDARDS REFER TO 2022 CBC (SFM) CHAPTER

NFPA 10-21 - Standard for PORTABLE FIRE EXTINGUISHERS

NFPA 17A-21 - STANDARD FOR WET CHEMICAL EXTINGUISHING SYSTEMS NFPA 20-19 - Standard for the Installation of Stationary Pumps for Fire Protection

NFPA 80-19 - Standard for Fire Doors and Other Opening Protectives

UL 521-99 - Standard for Heat Detectors for Fire Protective Signaling Systems

UL 1971-2002(r2010) - Standard for Signaling Devices for the Hearing Impaired

STATEMENT OF GENERAL CONFORMANCE

THE DRAWINGS SHEETS LISTED ON THE SHEET INDEX OF THIS COVER HAVE BEEN PREPARED BY OTHER DESIGN PROFESSIONALS OR CONSULTANTS WHO ARE LICENSED AND/OR AUTHORIZED TO PREPARE SUCH DRAWINGS IN THIS STATE. IT HAS BEEN EXAMINED BY ME FOR:

1) DESIGN INTENT, AND IT APPEARS TO MEET THE APPROPRIATE REQUIREMENTS OF TITLE 24, CALIFORNIA CODE OF REGULATIONS, AND THE PROJECT SPECIFICATIONS PREPARED BY ME, AND 2) COORDINATION WITH MY PLANS AND SPECIFICATIONS, AND IS ACCEPTABLE FOR INCORPORATION INTO THE CONSTRUCTION OF THIS PROJECT.

THE STATEMENT OF GENERAL CONFORMANCE "SHALL NOT BE CONSTRUED AS RELIEVING ME OF MY RIGHTS, DUTIES, AND RESPONSIBILITIES UNDER SECTIONS 17302 AND 81138 OF EDUCATION CODE,

AND SECTIONS 4-336, 4-341 AND 4-334 OF TITLE 24, PART 1 (TITLE 24, PART 1, SECTION 4-317 (B)). I FIND THAT: ■ ALL DRAWINGS OR SHEETS LISTED ON THE COVER OR INDEX SHEET


☐ THIS DRAWING OR PAGE ■ IS/ARE IN GENERAL CONFORMANCE WITH THE PROJECT DESIGN, AND

ARCHITECT OR ENGINEER DESIGNATED TO BE IN GENERAL RESPONSIBLE CHARGE

PRINT NAME LICENSE NUMBER

PROJECT LOCATION

10-31-25 **VICINITY MAP**

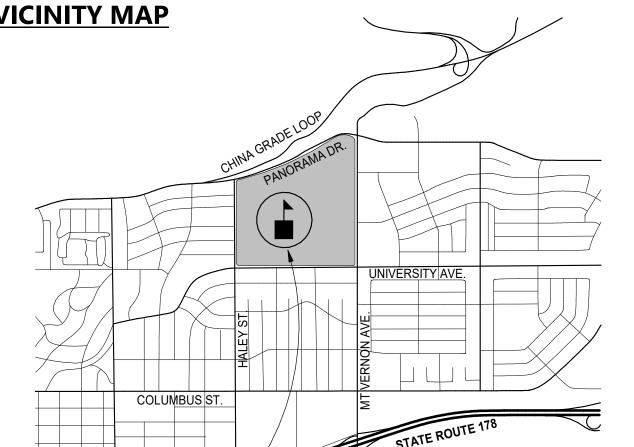

CONSULTANTS

802 EAST COTA STREET, SUITE A

SANTA BARBARA, CA 93103

TEL (805) 963-1955

<u>CIVIL ENGINEER</u> BLAIR, CHURCH, & FLYNN 451 Clovis Avenue Clovis, CA 93612 TEL (559) 326-1400

AGENCY APPROVAL <u>DSA#</u>

IDENTIFICATION STAMP DIV. OF THE STATE ARCHITE

REVIEWED FOR

SS 🗹 FLS 🗹 ACS 🗌

APP: 03-124690 INC:

DATE: 04/01/2025

<u>PLUMBING ENGINEER</u> 5000 East Spring Street, Suite 800 Long Beach, CA 90815 TEL (562) 497-2999

<u>MECHANICAL ENGINEER</u> 5000 East Spring Street, Suite 800 Long Beach, CA 90815 TEL (562) 497-2999

5000 East Spring Street, Suite 800 Long Beach, CA 90815 TEL (562) 497-2999

AQUATICS ENGINEER COUNSILMAN-HUNSAKER 12851 Manchester Road, Suite 120 St. Louis, MO 63131 TEL (314) 894-1245

CONSULTANT STAMP C-22474 REN. 10-31-25 REVISIONS

DESCRIPTION 10-04-2024 DSA SUBMITTAL DSA SUBMITTAL - V2 03-06-2025 03-27-2025 DSA SUBMITTAL - V3

THE ARCHITECT DOES NOT REPRESENT THAT THESE PLANS OR THE SPECIFICATIONS ARE SUITABLE FOR ANY SITE OTHER THAN THE ONE FOR WHICH THEY WERE SPECIFICALLY PREPARED. THE ARCHITECT DISCLAIMS RESPONSIBILITY FOR THESE PLANS AND ■ HAS/HAVE BEEN COORDINATED WITH THE PROJECT PLANS AND SPECIFICATIONS. SPECIFICATIONS IF THEY ARE USED IN WHOLE OR IN PART AT ANY OTHER SITE, WRITTEN

> ROJECT OWNER & TITLE KERN COMMUNITY COLLEGE DISTRICT 1801 Panorama Dr.

DIMENSIONS ON THESE DRAWINGS SHALL HAVE

PRECEDENCE OVER SCALED DIMENSIONS.

Bakersfield, CA 93305 Bakersfield College


Site Demolition

SHEET TITLE

TITLE SHEET

DRAWN BY: Author JOB NUMBER: 23024.01

G-001

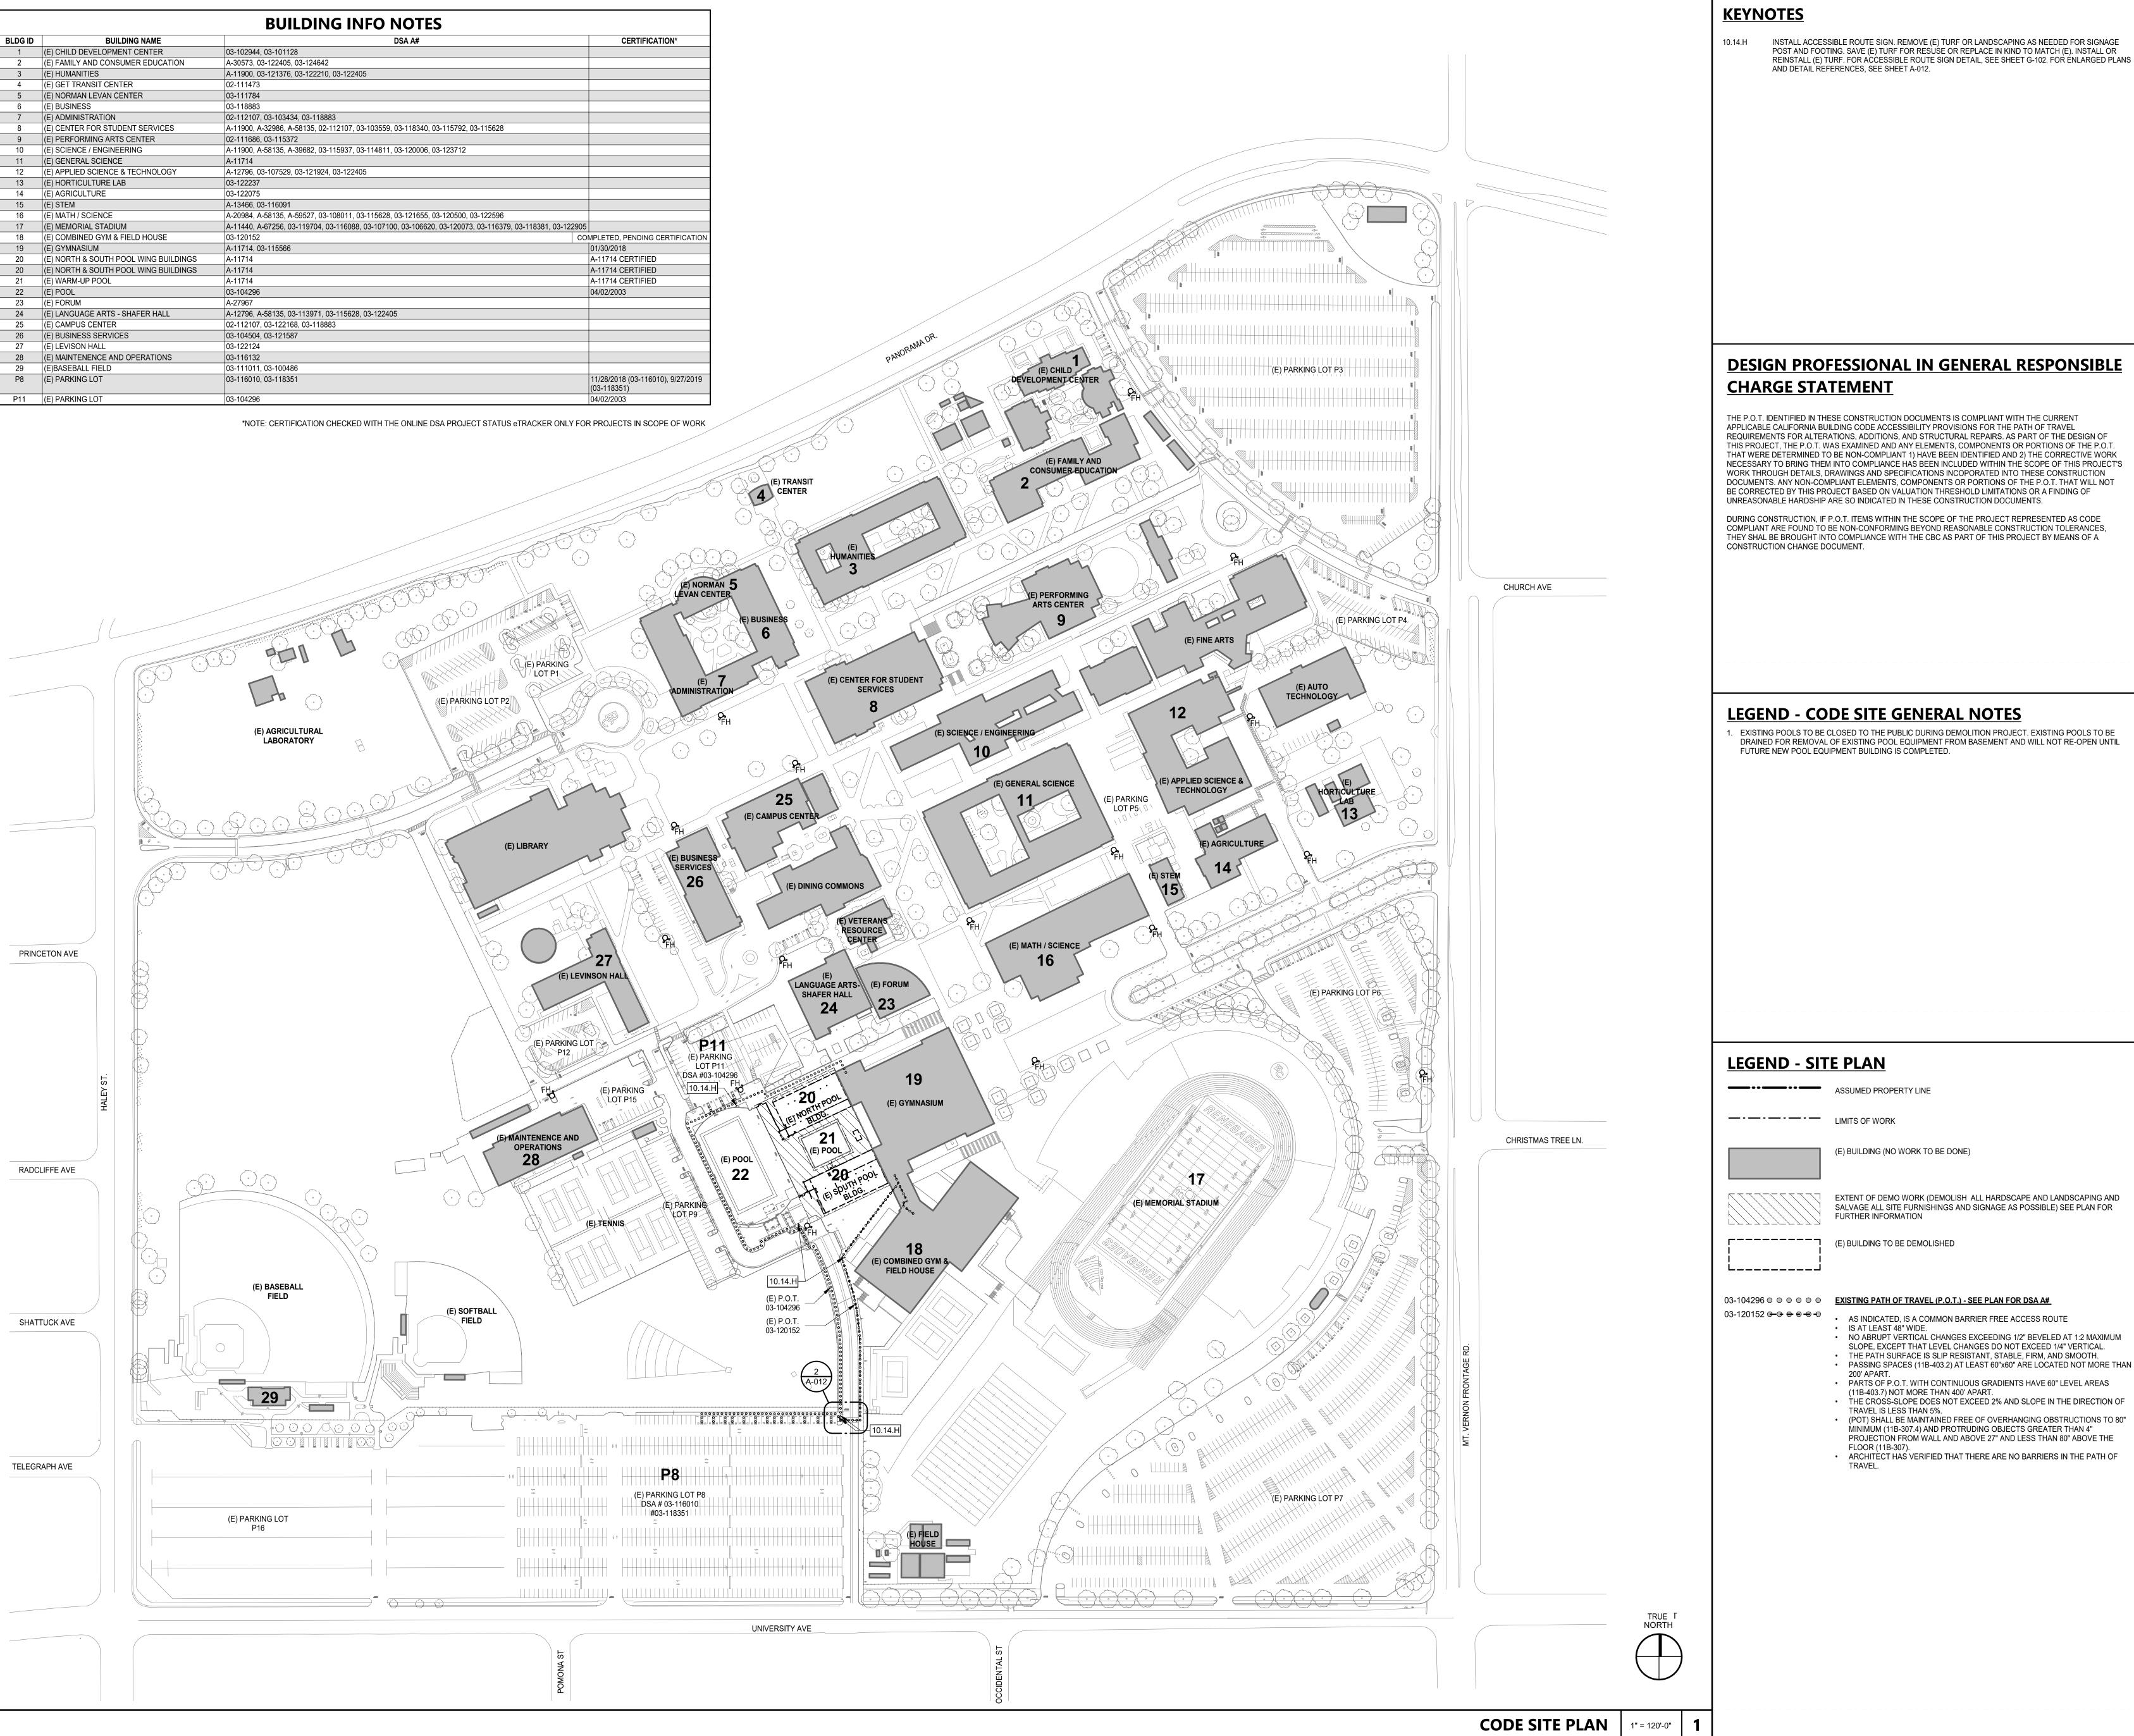

IDENTIFICATION STAMP DIV. OF THE STATE ARCHITEC APP: 03-124690 INC: REVIEWED FOR SS 🗹 FLS 🗹 ACS 🗌 DATE: 04/01/2025

802 EAST COTA STREET, SUITE A

SANTA BARBARA, CA 93103

TEL (805) 963-1955

DESIGN PROFESSIONAL IN GENERAL RESPONSIBLE

THE P.O.T. IDENTIFIED IN THESE CONSTRUCTION DOCUMENTS IS COMPLIANT WITH THE CURRENT APPLICABLE CALIFORNIA BUILDING CODE ACCESSIBILITY PROVISIONS FOR THE PATH OF TRAVEL REQUIREMENTS FOR ALTERATIONS, ADDITIONS, AND STRUCTURAL REPAIRS. AS PART OF THE DESIGN OF THIS PROJECT, THE P.O.T. WAS EXAMINED AND ANY ELEMENTS, COMPONENTS OR PORTIONS OF THE P.O.T. THAT WERE DETERMINED TO BE NON-COMPLIANT 1) HAVE BEEN IDENTIFIED AND 2) THE CORRECTIVE WORK NECESSARY TO BRING THEM INTO COMPLIANCE HAS BEEN INCLUDED WITHIN THE SCOPE OF THIS PROJECT'S WORK THROUGH DETAILS, DRAWINGS AND SPECIFICATIONS INCOPORATED INTO THESE CONSTRUCTION DOCUMENTS. ANY NON-COMPLIANT ELEMENTS, COMPONENTS OR PORTIONS OF THE P.O.T. THAT WILL NOT BE CORRECTED BY THIS PROJECT BASED ON VALUATION THRESHOLD LIMITATIONS OR A FINDING OF

DURING CONSTRUCTION, IF P.O.T. ITEMS WITHIN THE SCOPE OF THE PROJECT REPRESENTED AS CODE COMPLIANT ARE FOUND TO BE NON-CONFORMING BEYOND REASONABLE CONSTRUCTION TOLERANCES, THEY SHAL BE BROUGHT INTO COMPLIANCE WITH THE CBC AS PART OF THIS PROJECT BY MEANS OF A

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451 Clovis Avenue

Clovis, CA 93612

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Long Beach, CA 90815

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> CONSULTANT STAMP C-22474 REN. 10-31-25

DESCRIPTION DATE

EXTENT OF DEMO WORK (DEMOLISH ALL HARDSCAPE AND LANDSCAPING AND SALVAGE ALL SITE FURNISHINGS AND SIGNAGE AS POSSIBLE) SEE PLAN FOR

AS INDICATED, IS A COMMON BARRIER FREE ACCESS ROUTE

- NO ABRUPT VERTICAL CHANGES EXCEEDING 1/2" BEVELED AT 1:2 MAXIMUM SLOPE, EXCEPT THAT LEVEL CHANGES DO NOT EXCEED 1/4" VERTICAL. THE PATH SURFACE IS SLIP RESISTANT, STABLE, FIRM, AND SMOOTH.
- PARTS OF P.O.T. WITH CONTINUOUS GRADIENTS HAVE 60" LEVEL AREAS THE CROSS-SLOPE DOES NOT EXCEED 2% AND SLOPE IN THE DIRECTION OF
- (POT) SHALL BE MAINTAINED FREE OF OVERHANGING OBSTRUCTIONS TO 80" MINIMUM (11B-307.4) AND PROTRUDING OBJECTS GREATER THAN 4" PROJECTION FROM WALL AND ABOVE 27" AND LESS THAN 80" ABOVE THE
- ARCHITECT HAS VERIFIED THAT THERE ARE NO BARRIERS IN THE PATH OF

PRECEDENCE OVER SCALED DIMENSIONS. ROJECT OWNER & TITLE KERN COMMUNITY COLLEGE DISTRICT

THE ARCHITECT DOES NOT REPRESENT THAT THESE PLANS OR THE SPECIFICATIONS ARE

SUITABLE FOR ANY SITE OTHER THAN THE ONE

SPECIFICATIONS IF THEY ARE USED IN WHOLE OR

DIMENSIONS ON THESE DRAWINGS SHALL HAVE

FOR WHICH THEY WERE SPECIFICALLY

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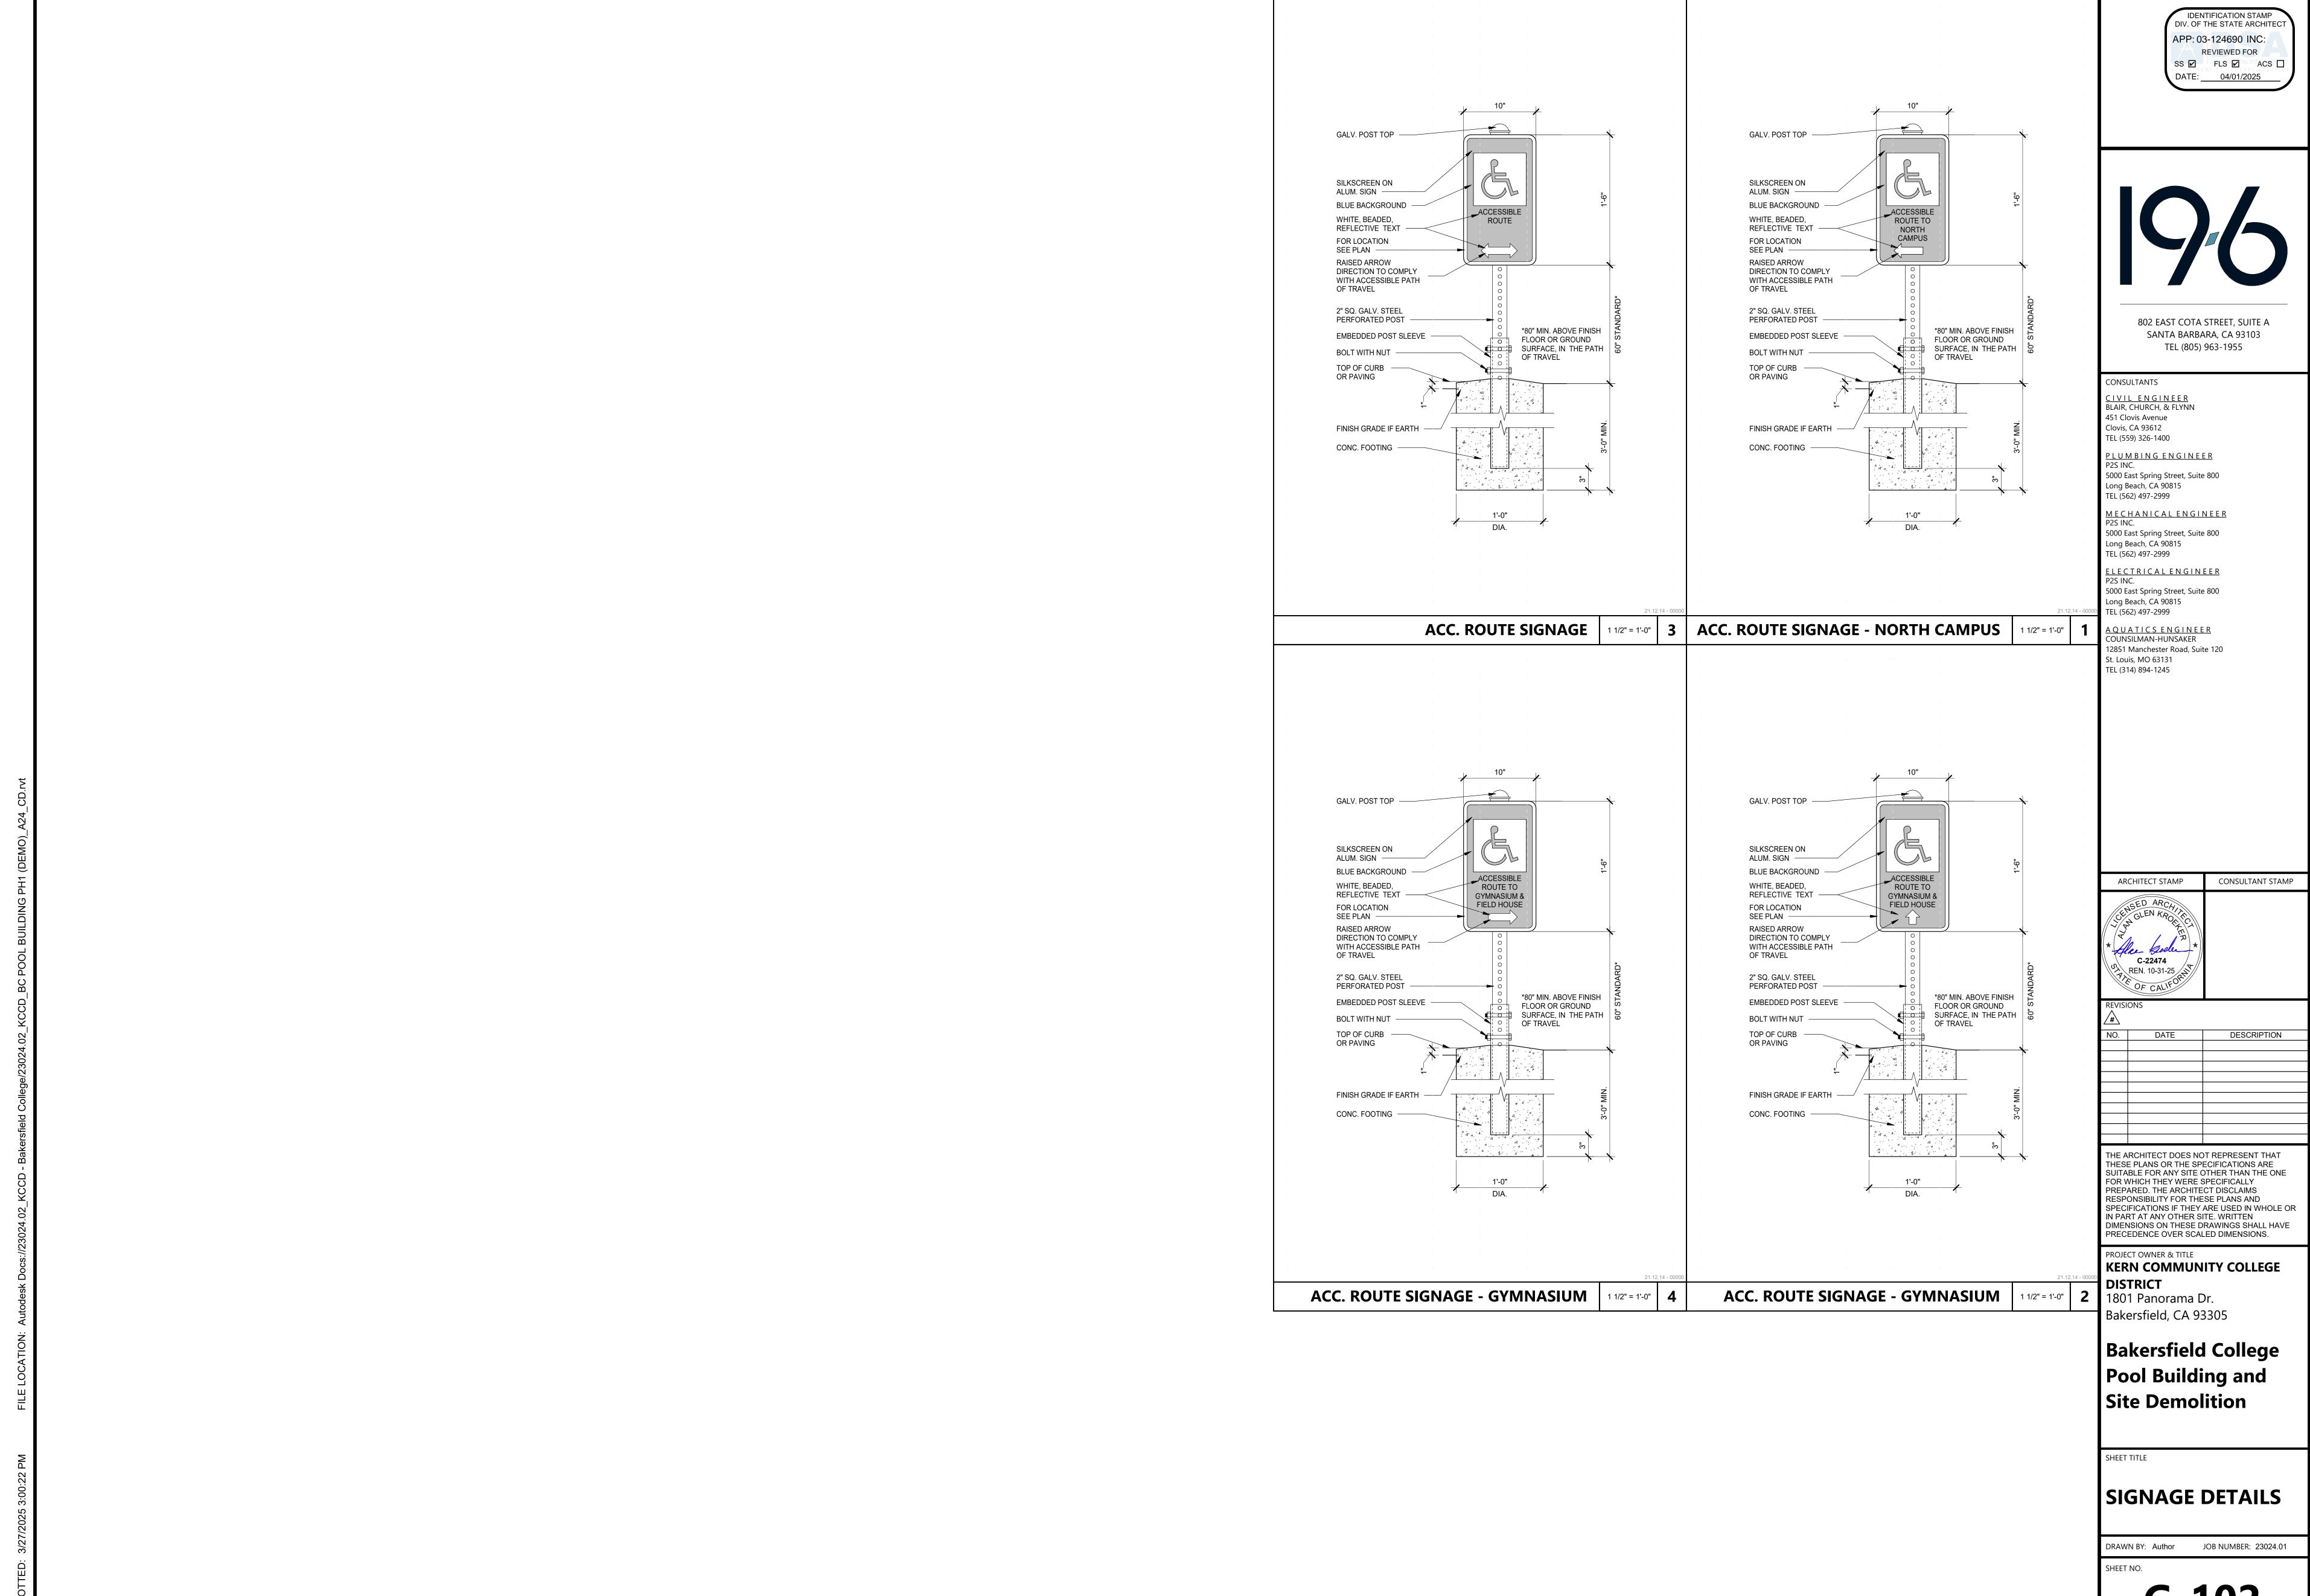
IN PART AT ANY OTHER SITE. WRITTEN

1801 Panorama Dr. Bakersfield, CA 93305

Bakersfield College Pool Building and Site Demolition

CODE SITE PLAN

DRAWN BY: Author JOB NUMBER: 23024.01



G-102

DATE: MARCH 27, 2025

CONSULTANTS

CIVIL ENGINEER
BLAIR, CHURCH, & FLYNN
451 Clovis Avenue
Clovis, CA 93612
TEL (559) 326-1400

PLUMBING ENGINEER
P2S INC.
5000 East Spring Street, Suite 800
Long Beach, CA 90815
TEL (562) 497-2999

MECHANICAL ENGINEER
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ELECTRICAL ENGINEER
P2S INC.
5000 East Spring Street, Suite 800
Long Beach, CA 90815
TEL (562) 497-2999

A Q U A T I C S E N G I N E E R COUNSILMAN-HUNSAKER 12851 Manchester Road, Suite 120 St. Louis, MO 63131 TEL (314) 894-1245

ARCHITECT STAMP

CONSULTANT STAMP

PROFESSIONAL

R. BADICE

REVISIONS

NO. DATE DESCRIPTION

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SPECIFICATIONS IF THEY ARE USED IN WHOLE OR
IN PART AT ANY OTHER SITE

KERN COMMUNITY COLLEGE
DISTRICT
2100 Chester Avenue,
Bakersfield, CA 93301

PROJECT OWNER & TITLE

BAKERSFIELD
COLLEGE POOL
BUILDING AND SITE
DEMOLITION

1801 Panorama Dr. Bakersfield, CA 93305

TOPOGRAPHIC SURVEY LEGEND

SURVEY LEGEND AND NOTES

RAWN BY: S.JUE JOB NUMBER: 23024.01

T NO.

DATE: MARCH 27, 2025

GENERAL TOPOGRAPHIC SURVEY LEGEND:

(NOT ALL SYMB	OLS SHOWN APPEAR ON THE PLANS)	PA	PATIO	○ <i>BO</i>	BOLLARD	∘ 4"SLE	PIPE SLEEVE; DIAMETER AS SHOWN	——————————————————————————————————————	AGRICULTURAL IRRIGATION LINE; SIZE AS
AB	ABUTMENT	PGTH	PROPANE GAS TRENCH	0 <i>CO</i>	CLEANOUT	>—	SLOPE	1"	NOTED
AC	ASPHALTIC CONCRETE	POS	POINT ON SLOPE	□ COPB	COMMUNICATION PULLBOX	□ SLPB	STREET LIGHT PULLBOX	A	AIR LINE; SIZE AS NOTED
ACE	ASPHALTIC CONCRETE EDGE	RCP	REINFORCED CONCRETE	□CVA	COMMUNICATION VAULT	∘ 4"SLV	PIPE SLEEVE; DIAMETER AS SHOWN	C	COMMUNICATION LINE
AD	ASPHALTIC CONCRETE DIKE	RIEL	RIPARIAN EDGE OF LAKE	<u></u>	SURVEY CONTROL MONUMENT	(§)	SEWER MANHOLE		MAJOR GRADE CONTOUR LINE
<i>AWT</i>	ALL-WEATHER TRACK	RIEP	RIPARIAN EDGE OF POND	o DF	DRINKING FOUNTAIN	∑ SP	SERVICE POLE	<i>345</i>	MINOR GRADE CONTOUR LINE
BD	BRIDGE DECK	RIES	RIPARIAN EDGE OF STREAM	o DS	DOORSTOP	\Box SPB	SIGNAL PULLBOX	CW	CHILLED WATER LINE; SIZE AS NOTED
BFC	BOTTOM FACE OF CURB	RIEW	RIPARIAN EDGE OF WETLAND	ODW	DRYWELL	*	SPRINKLER	CWR ^{2"}	CHILLED WATER RETURN LINE; SIZE AS NOTED
BGST	STEPS	RIFL	RIPARIAN FLOWLINE	∘ <i>EG</i>	ELECTRICAL GROUND	o 4" SPO	STEEL POST; DIAMETER AS SHOWN	CWS ^{2"}	CHILLED WATER SUPPLY LINE; SIZE AS NOTED
BGTR	TOP OF ROOF	RIMC	RIPARIAN MISC.	o ELC	ELECTRICAL CONDUIT	o <i>12"SS</i>	SAND SEPARATOR; SIZE AS NOTED		•
BGV	BUILDING VENTS	RIP	RIP-RAP SLOPE PROTECTION	E	ELECTRICAL METER	○ 24"STP	STAND PIPE; DIAMETER AS NOTED		
BOD	BOTTOM OF DITCH	RK	ROCK	□ EPB	ELECTRICAL PULLBOX	⊙ 12"STUMP	TREE STUMP; DIAMETER AS SHOWN		DRAIN LINE; SIZE AS NOTED
BR	BARRICADE	RW	RETAINING WALL	E	ELECTRICAL VAULT LID	O MW	SURVEY MONUMENT WELL		·
BRK	BRICK	SB	SPEED BUMP	o ETS	GAS ELECTRONIC TESTING STATION	∘ 4"TEL	TELEPHONE; DIAMETER AS SHOWN		EMERGENCY MANAGEMENT SYSTEM
BW	BARRIER WALL	SDCD	STORM DRAIN CROSS DRAIN	\bigcap FDC	FIRE DEPARTMENT CONNECTION	T	TELEPHONE MANHOLE		FIRE ALARM LINE
СВ	CATCH BASIN	SDFL	STORM DRAIN FLOWLINE	đ	FIRE HYDRANT	<i>○TN</i>	TENNIS NET POLE	F-8	FIRE LINE; SIZE AS NOTED
CDA	CONCRETE DRIVE APPROACH	SDGR	STORM DRAIN GRATE	0 <i>FP</i>	FENCE POST	Ø TP	TELEPHONE POLE	F0	FIBER OPTIC LINE
CE	CONCRETE EDGE	SDMG	STORM DRAIN MANHOLE W/ GRATE	o <i>FLP</i>	FLAG POLE	□ TPB	TELEPHONE PULLBOX	=======	DRAIN TUBE
CMP	CORRUGATED METAL PIPE	SSFL	SEWER FLOWLINE	o GAS	GAS LINE; DIAMETER AS SHOWN	□ <i>TVPB</i>	TELEVISION PULLBOX	HW 2"	HOT WATER LINE; SIZE AS NOTED
CON	CONCRETE	SDTH	STORM DRAIN TRENCH	☐ GR	GAS REGULATOR		TREE; SPREAD SHOWN GRAPHICALLY AND	HWR ^{2"}	HOT WATER RETURN LINE; SIZE AS NOTED
сотн	COMMUNICATION TRENCH	SSGT	STORM DRAIN GREASE TRAP	<i>GAV</i> ⊳<	IRRIGATION GATE VALVE	(6)	TRUNK DIAMETER AS SHOWN	HWS ² "	HOT WATER SUPPLY LINE; SIZE AS NOTED
CR	CROWN OF ROAD	SSST	SEWER TANK (SEPTIC)	G	GAS METER	¥, ¥			,
CRQ	QUARTER CROWN	SSTH	SEWER TRENCH	○ <i>GOP</i>	GOAL POST		PALM TREE; SPREAD SHOWN GRAPHICALLY	——————————————————————————————————————	HYDRAULIC LINE
cs	CONCRETE SLAB	SWK	SIDEWALK	○ <i>GP</i>	GUY POLE	***************************************		ID	IRRIGATION DISTRICT; SIZE AS NOTED
CULV	CULVERT	SWL	SWALE	∘ <i>GS</i>	GATE STOP	□ TSB	TELEPHONE SPLICE BOX		IRON FENCE
CW	CONCRETE WALL	Т	TURF	∘ <i>GSR</i>	GAS RISER	←	TRAFFIC SIGNAL POLE	IRR 3"	IRRIGATION MAIN LINE; SIZE AS NOTED
DD	DOWN DRAIN	TBC	TOP BACK OF CURB	⊕ <i>GV</i>	GAS VALVE	□ TSPB	TRAFFIC SIGNAL PULLBOX	L	IRRIGATION LATERAL LINE; SIZE AS NOTED
DFL	DITCH FLOWLINE	TBW	TOP BACK OF WALK	∘ <i>GRD</i>	GROUNDING ROD	∑ UP	UTILITY POLE	——— ITS ———	INTELLIGENT TRAFFIC SYSTEM
DWY	DRIVEWAY	TF	TOP OF FOOTING	GUY	GUY WIRE	∘ <i>VB</i>	VACUUM BREAKER	JT	JOINTLY TRENCHED UTILITIES
ECTH	ELECTRICAL TRENCH	TFC	TOP FACE OF CURB	∘ <i>HB</i>	HOSE BIBB	∘ <i>W</i> V	VOLLEYBALL NET POST	oc	OVERHEAD COMMUNICATIONS LINE
EDR	EDGE OF DIRT ROAD	TFW	TOP FACE OF WALK	∘ <i>HR</i>	HANDRAIL	∘ 2″VP	VENT PIPE; DIAMETER AS SHOWN		OVERHEAD ELECTRIC LINE
EGR	EDGE OF GRAVEL ROAD	TLTH	TELEPHONE TRENCH	\Box ICB	IRRIGATION CONTROLLER	○ WELL	WELL	OEC	OVERHEAD ELECTRIC AND COMMUNICATION
EOD	EDGE OF OILED DIRT	ТОВ	TOP OF BANK		IRRIGATION DISTRICT MANHOLE	W	WATER METER		LINE
EP	EDGE OF PAVEMENT	TOE	TOE OF SLOPE	/VA	IRRIGATION REMOTE CONTROL VALVE	⊗ WP	WELL PUMP	OET	OVERHEAD ELECTRIC AND TELEPHONE LINE
ES	EDGE OF SHOULDER	TOP	TOP OF SLOPE	/SB ⊳<	IRRIGATION SPLICE BOX	∘ <i>6"WPO</i>	CIRCULAR WOOD POST; DIAMETER AS SHOWN	OETV	OVERHEAD ELECTRIC AND TELEVISION LINE
ET	EDGE OF TRAVELED WAY	TRDO	TRUNCATED DOMES	□ <i>IHB</i>	IN-GROUND HOSE BIBB	□ 4"X4"WPO	SQUARE WOOD POST; SIZE AS SHOWN		OVERHEAD ELECTRIC, TELEVISION AND TELEPHONE LINE
FF	FINISH FLOOR	TVTH	TV TRENCH	• <i>IP</i>	IRON PIPE	∘ 4"W	WATER LINE; DIAMETER AS SHOWN	OTS	OVERHEAD TRAFFIC SIGNAL LINE
FOTH	FIBER OPTIC TRENCH	ΤW	TOP OF WALL	 OJP	JOINT UTILITY POLE	$\oplus wv$	WATER VALVE	OTV	OVERHEAD TELEVISION LINE
GB	GRADE BREAK	ИТН	UNIDENTIFIED TRENCH/SCAR LINE		LIGHT POLE		ASPHALT PAVEMENT	OU	OVERHEAD UTILITY LINE
GFL	GUTTER FLOWLINE	VGFL	VALLEY GUTTER FLOWLINE	·			CONCRETE BLOCK WALL	P_ <i>_6"</i>	PETROLEUM LINE; SIZE AS NOTED
GR	GRATE	VGR	VALLEY GUTTER	⊠ MB	MANUAL F	7////	BUILDING		RECYCLED WATER IRRIGATION LINE; SIZE AS
GRA	GRAVEL SPOT SHOT	WALBA	BARRIER WALL	(MH)	MANHOLE	F			NOTED
GRAE	EDGE OF GRAVEL	WALBW	BLOCK WALL	<i>M</i> /	MANUAL IRRIGATION VALVE		CONCRETE	———— S&SD 8"	SEWER AND STORM DRAIN LINE; SIZE AS NOTED
GSTH	GAS TRENCH	WALCW	CONCRETE WALL	□ <i>PB</i>	PULLBOX		DETECTABLE WARNINGS	SFM <u>6"</u>	SEWER FORCE MAIN; SIZE AS NOTED
HDR	WOOD HEADER	WALHW	HEAD WALL	PIV	POST INDICATOR VALVE		DG OR GRAVEL		STEAM LINE; SIZE AS NOTED
HW	HEAD WALL	WALRW	RETAINING WALL	├ ─	UTILITY STUB		CHAIN LINK FENCE		
KR	K-RAIL	WALWW	WING WALL		PARKING METER		CHAIN LINK ROLL GATE		TRAFFIC FIBER OPTIC LINE
LIP	LIP OF GUTTER	WCR	WHEELCHAIR RAMP	∘ 4"POST	POST; DIAMETER AS SHOWN		EDGE OF ASPHALT PAVEMENT		TRAFFIC SIGNAL LINE
LSDE	DECOMPOSED GRANITE EDGE	WLPD	WELL PAD) PP	POWER POLE	0			TELEVISION LINE
LSDG	DECOMPOSED GRANITE	WTTH	WATER TRENCH	∘ 6″PVC	PVC PIPE; DIAMETER AS SHOWN				UNKNOWN UTILITY LINE
LSGC	GROUND COVER	ww	WING WALL	\triangle QC	QUICK COUPLER VALVE		UNDERGROUND ELECTRIC	— X — X	
LSGF	GOLF COURSE FAIRWAY	(335.21)	EXISTING ELEVATION	∘ <i>RD</i>	ROOF DRAIN				PROPERTY LINE
LSGG	GOLF COURSE GREEN	O AL	ACCENT LIGHT	∘ <i>RDU</i>	ROOF DRAIN UNDERGROUND		GAS LINE; SIZE AS NOTED		
LSGT	GOLF COURSE TEE	AV ⋈	ALFALFA VALVE	。 RS	ROOF SUPPORT		OVERHEAD TELEPHONE		
LSSA	SAND		BACKFLOW ASSEMBLY	\triangle \triangle \triangle	STADIUM LIGHT POLE	———— SD <u>18"</u>	STORM DRAIN LINE; SIZE AS NOTED		
LSSP	SLOPE PROTECTION	√ l₀		(D)	STORM DRAIN MANHOLE	S12"	SEWER LINE; SIZE AS NOTED		RIGHT-OF-WAY LINE
LSST	GOLF COURSE SAND TRAP		BASKETBALL GOAL	- 0-	SIGN	——т—	UNDERGROUND TELEPHONE		RIGHT-OF-WAY CENTER LINE
NPTH	NON-POTABLE TRENCH	∘ BOV	BLOW-OFF VALVE	© PPB	SIGNAL LIGHT PUSH BUTTON		WATER LINE; SIZE AS NOTED		SETBACK LINE
		•	BM=BENCHMARK; OR SBM=SITE BENCHMARK	○ ────────────────────────────────────	STREET LIGHT		,		

SURVEY NOTES:

- 1. THIS TOPOGRAPHIC SURVEY LOCATES SPECIFIC PHYSICAL FEATURES
 OF THE SITE AND THEIR ELEVATION AS DETERMINED NECESSARY BY THE
 PROJECT ENGINEER. IT IS NOT A COMPLETE TOPOGRAPHIC SURVEY OF
 THE SITE. THE INFORMATION SHOWN REFLECTS THE DATA OBTAINED BY
 FIELD SURVEY CONDUCTED ON MARCH 19, 2024.
- 2. UTILITY INFORMATION SHOWN HEREON IS BASED ON RECORD INFORMATION SUPPLIED TO THE ENGINEER BY UTILITY COMPANIES, PUBLIC AGENCIES AND THE PROPERTY OWNER, TOGETHER WITH OBSERVATION OF VISIBLE EVIDENCE BY A FIELD SURVEY. THE ENGINEER CAN MAKE NO GUARANTEE AS TO THE ACCURACY OR COMPLETENESS OF THE UNDERGROUND UTILITY FACILITIES SHOWN. PRIOR TO ANY SITE EXCAVATIONS, THE CONTRACTOR SHALL CONTACT THE OWNER AND UNDERGROUND SERVICE ALERT (USA) AND REQUEST THAT THEY IDENTIFY THE LOCATION OF ALL UNDERGROUND UTILITIES AT THE SITE.

SITE BENCHMARK:

CHISELED "X" IN CONCRETE WALK APPROXIMATELY 46' SOUTHWEST OF THE SOUTHWEST CORNER OF THE POOL BUILDING SOUTH WING.

ELEV.= 54.68' BAKERSFIELD COLLEGE DATUM

802 EAST COTA STREET, SUITE A SANTA BARBARA, CA 93103 TEL (805) 963-1955

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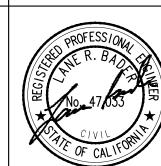
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AQUATICS ENGINEER COUNSILMAN-HUNSAKER 12851 Manchester Road, Suite 120 St. Louis, MO 63131 TEL (314) 894-1245

ARCHITECT STAMP CONSULTANT STAMP



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PROJECT OWNER & TITLE KERN COMMUNITY COLLEGE **DISTRICT** 2100 Chester Avenue, Bakersfield, CA 93301

BAKERSFIELD COLLEGE POOL

BUILDING AND SITE DEMOLITION


1801 Panorama Dr. Bakersfield, CA 93305

TOPOGRAPHIC SURVEY

DRAWN BY: S.JUE JOB NUMBER: 23024.01

C-101

DATE: MARCH 27, 2025

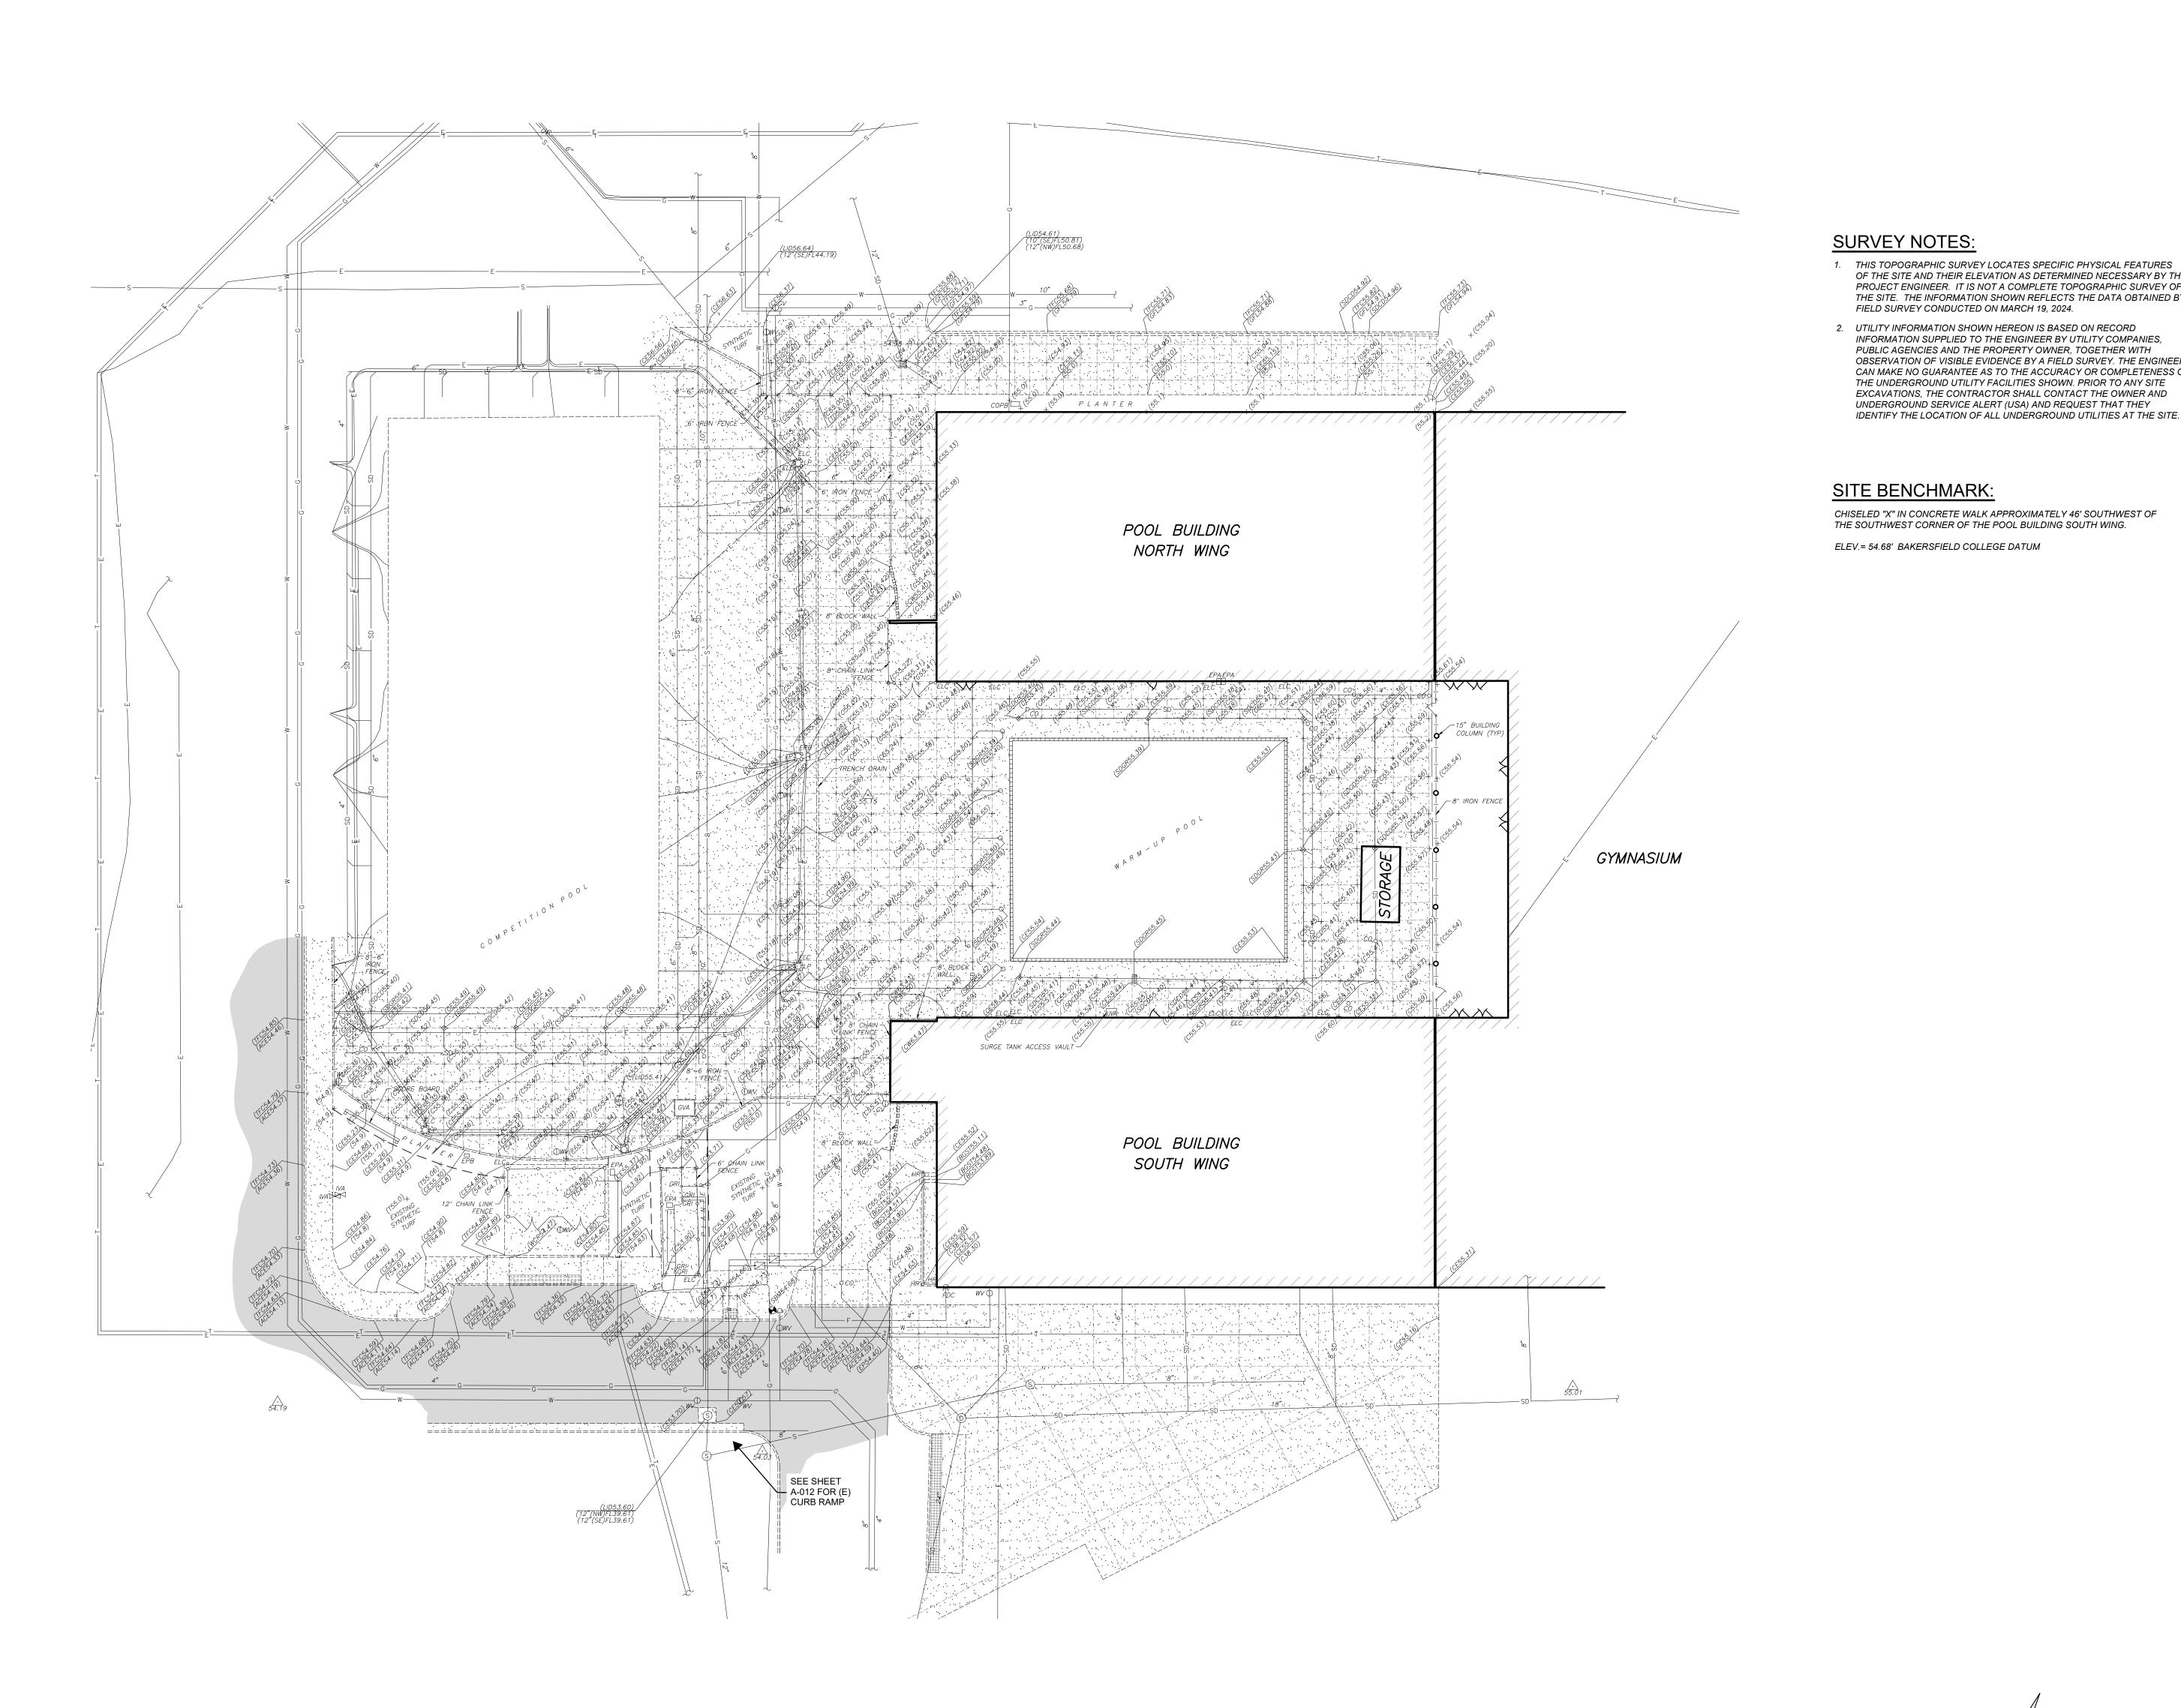

SCALE: (N) 1"=20'

OF THE SITE AND THEIR ELEVATION AS DETERMINED NECESSARY BY THE PROJECT ENGINEER. IT IS NOT A COMPLETE TOPOGRAPHIC SURVEY OF THE SITE. THE INFORMATION SHOWN REFLECTS THE DATA OBTAINED BY

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OBSERVATION OF VISIBLE EVIDENCE BY A FIELD SURVEY. THE ENGINEER CAN MAKE NO GUARANTEE AS TO THE ACCURACY OR COMPLETENESS OF

FIELD SURVEY CONDUCTED ON MARCH 19, 2024.

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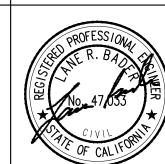
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PROJECT OWNER & TITLE KERN COMMUNITY COLLEGE


DISTRICT 2100 Chester Avenue, Bakersfield, CA 93301

BAKERSFIELD **COLLEGE POOL BUILDING AND SITE** DEMOLITION

1801 Panorama Dr. Bakersfield, CA 93305

DEMOLITION PLAN

JOB NUMBER: 23024.01 DRAWN BY: S.JUE

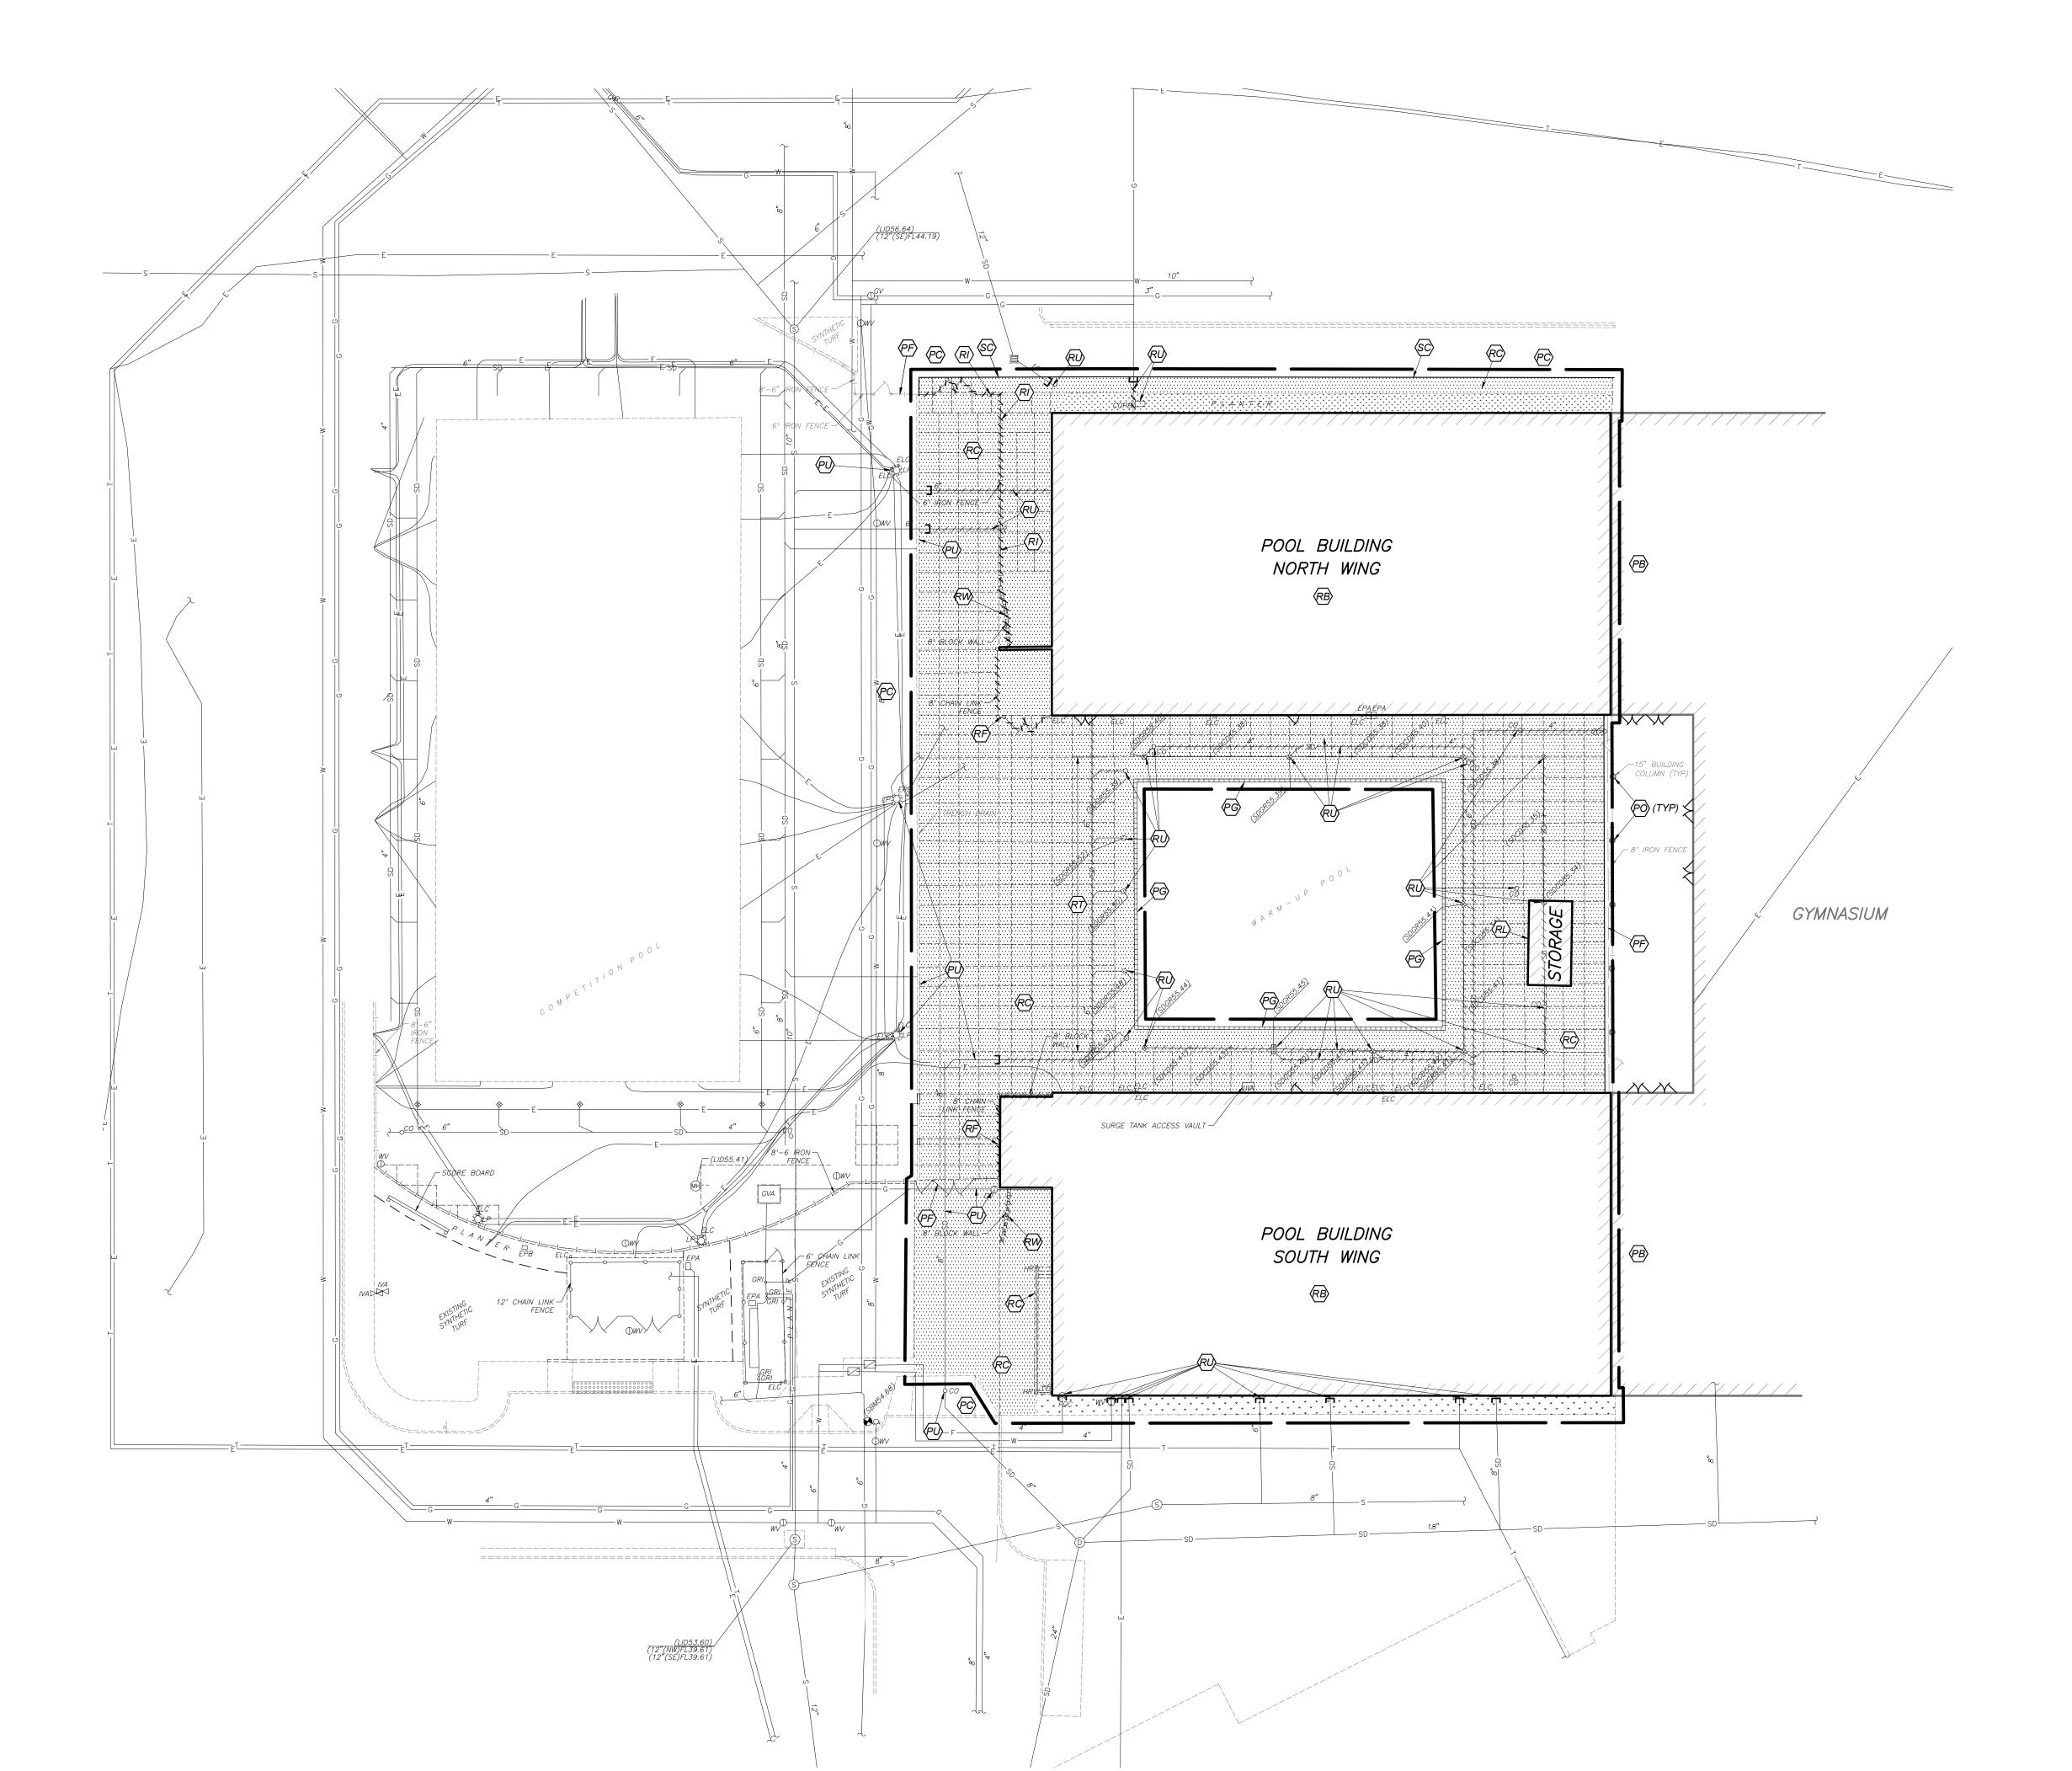

DEMOLITION LEGEND:

REMOVE EXISTING IMPROVEMENTS AS NECESSARY TO CONSTRUCT NEW

REMOVAL OF IMPROVEMENTS MUST BE COORDINATED WITH ALL PLAN SHEETS. CONTRACTOR MUST ALSO COORDINATE REMOVAL OF IMPROVEMENTS WITH UTILITY AGENCIES. PROTECT ALL IMPROVEMENTS NOT DESIGNATED FOR REMOVAL. SEE NOTE 1

LIMITS OF VEGETATION REMOVAL. 4" MINIMUM DEPTH

PROTECT BUILDING TO REMAIN

PROTECT FENCE TO REMAIN

PROTECT UTILITY TO REMAIN

INFORMATION

IMPROVEMENTS

AND FOOTINGS.

SEE NOTE 10

SAWCUT

WALL AND FOOTING

LIMIT OF STORM DRAIN LINE REMOVAL

-/-/-/S-/-/- LIMIT OF SEWER LINE REMOVAL

-/-/-/w-/-/- LIMIT OF WATER LINE REMOVAL

CONNECTION

マママママケケケケキャ LIMIT OF CONCRETE BLOCK WALL REMOVAL

→ → → → → → → → → → LIMIT OF DECORATIVE METAL FENCE REMOVAL

BASE, AND DRAIN PIPES TO REMAIN

PROTECT BUILDING COLUMN TO REMAIN

REMOVE AND LAWFULLY DISPOSE OF

IMPROVEMENTS SHOWN ON THESE PLANS UNLESS OTHERWISE NOTED ON THE PLAN. THE

LIMITS OF CONCRETE IMPROVEMENT REMOVAL

PROTECT POOL OVERFLOW GUTTER, CONCRETE

REMOVE AND LAWFULLY DISPOSE OF BUILDING, SEE ARCHITECTURAL PLANS FOR ADDITIONAL

REMOVE AND LAWFULLY DISPOSE OF CONCRETE

DECORATIVE METAL FENCE PICKETS, POSTS,

REMOVE AND LAWFULLY DISPOSE OF CHAIN

SALVAGE AND RELOCATE STORAGE BUILDING,

DEMOLISH AND BACKFILL TUNNEL UNDER POOL

REMOVE AND LAWFULLY DISPOSE OF UTILITY,

REMOVE AND LAWFULLY DISPOSE OF BLOCK

CAP END OF UTILITY LINE WITH WATER-TIGHT

COORDINATE NEW LOCATION WITH OWNER

DECK PER ARCHITECTURAL PLANS

LINK FENCE FABRIC, POSTS AND FOOTINGS

PROTECT CONCRETE IMPROVEMENTS TO

GENERAL DEMOLITION NOTES: 1. THE "LIMIT OF DEMOLITION" SHOWN IS APPROXIMATE AND IS

GENERALLY CONSIDERED TO BE THE MINIMUM REMOVAL REQUIREMENTS. CONTRACTOR MUST COORDINATE AS NOTED IN THE LEGEND.

2. CONTRACTOR SHALL LEGALLY DISPOSE OF ALL DEMOLISHED MATERIALS OFF SITE.

CONTRACTOR SHALL PROTECT ALL EXISTING UTILITY IMPROVEMENTS NOT SPECIFICALLY DESIGNATED FOR

4. THE ON-SITE UNDERGROUND UTILITIES SHOWN ON THIS SHEET ARE AT APPROXIMATE LOCATIONS. THE EXTENT, LOCATIONS AND SIZES ARE UNKNOWN. THE CONTRACTOR SHALL POTHOLE TO LOCATE AND VERIFY THE UNDERGROUND UTILITY LINES PRIOR TO REMOVAL.

5. CONTRACTOR TO PROTECT AND PRESERVE IN PLACE ANY FOUND SURVEY MONUMENTS. ANY MONUMENTS DISTURBED SHALL BE RESET BY A CALIFORNIA LICENSED SURVEYOR AND THE APPROPRIATE PAPERWORK FILED WITH THE CITY OR COUNTY, AT CONTRACTOR'S EXPENSE.

6. ALL HAZARDOUS MATERIALS ENCOUNTERED DURING SITE DEMOLITION SHALL BE REMEDIATED AND DISPOSED OF PER STATE AND EPA REQUIREMENTS.

CONTRACTOR SHALL CONTACT AND COORDINATE WITH ALL UTILITY AGENCIES PRIOR TO THE START OF ANY DEMOLITION OR CONSTRUCTION.

8. ANY EXISTING UTILITIES AND/OR IMPROVEMENTS WHICH ARE TO REMAIN, THAT BECOME DAMAGED DURING CONSTRUCTION SHALL BE COMPLETELY RESTORED TO THE SATISFACTION OF THE OWNER AND AGENCY HAVING AUTHORITY, AT THE CONTRACTOR'S SOLE EXPENSE. 9. REMOVE EXISTING IMPROVEMENTS AS NECESSARY TO


CONSTRUCT NEW IMPROVEMENTS SHOWN ON THESE PLANS.

a) FOR CONCRETE REMOVAL, REMOVE TO THE NEXT NEAREST TOOLED JOINT OR EXPANSION JOINT OF IMPROVEMENTS DESIGNATED TO REMAIN.


10. REFER TO MECHANICAL, ELECTRICAL, PLUMBING, AND ARCHITECTURAL PLANS FOR ADDITIONAL DEMOLITION AND COORDINATION.

11. COMPLIANCE WITH FIRE SAFETY DURING CONSTRUCTION WILL BE ENFORCED.

12. DURING DEMOLITION, DISCONNECT AND PROTECT POOL DECK BONDING WIRES WHERE FOUND. PROTECT IN PLACE FOR RE-CONNECTION TO NEW POOL DECK BONDING.

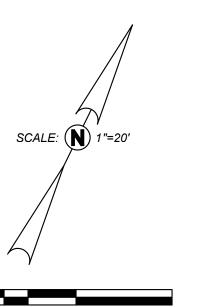

Know what's below. Call before you dig.

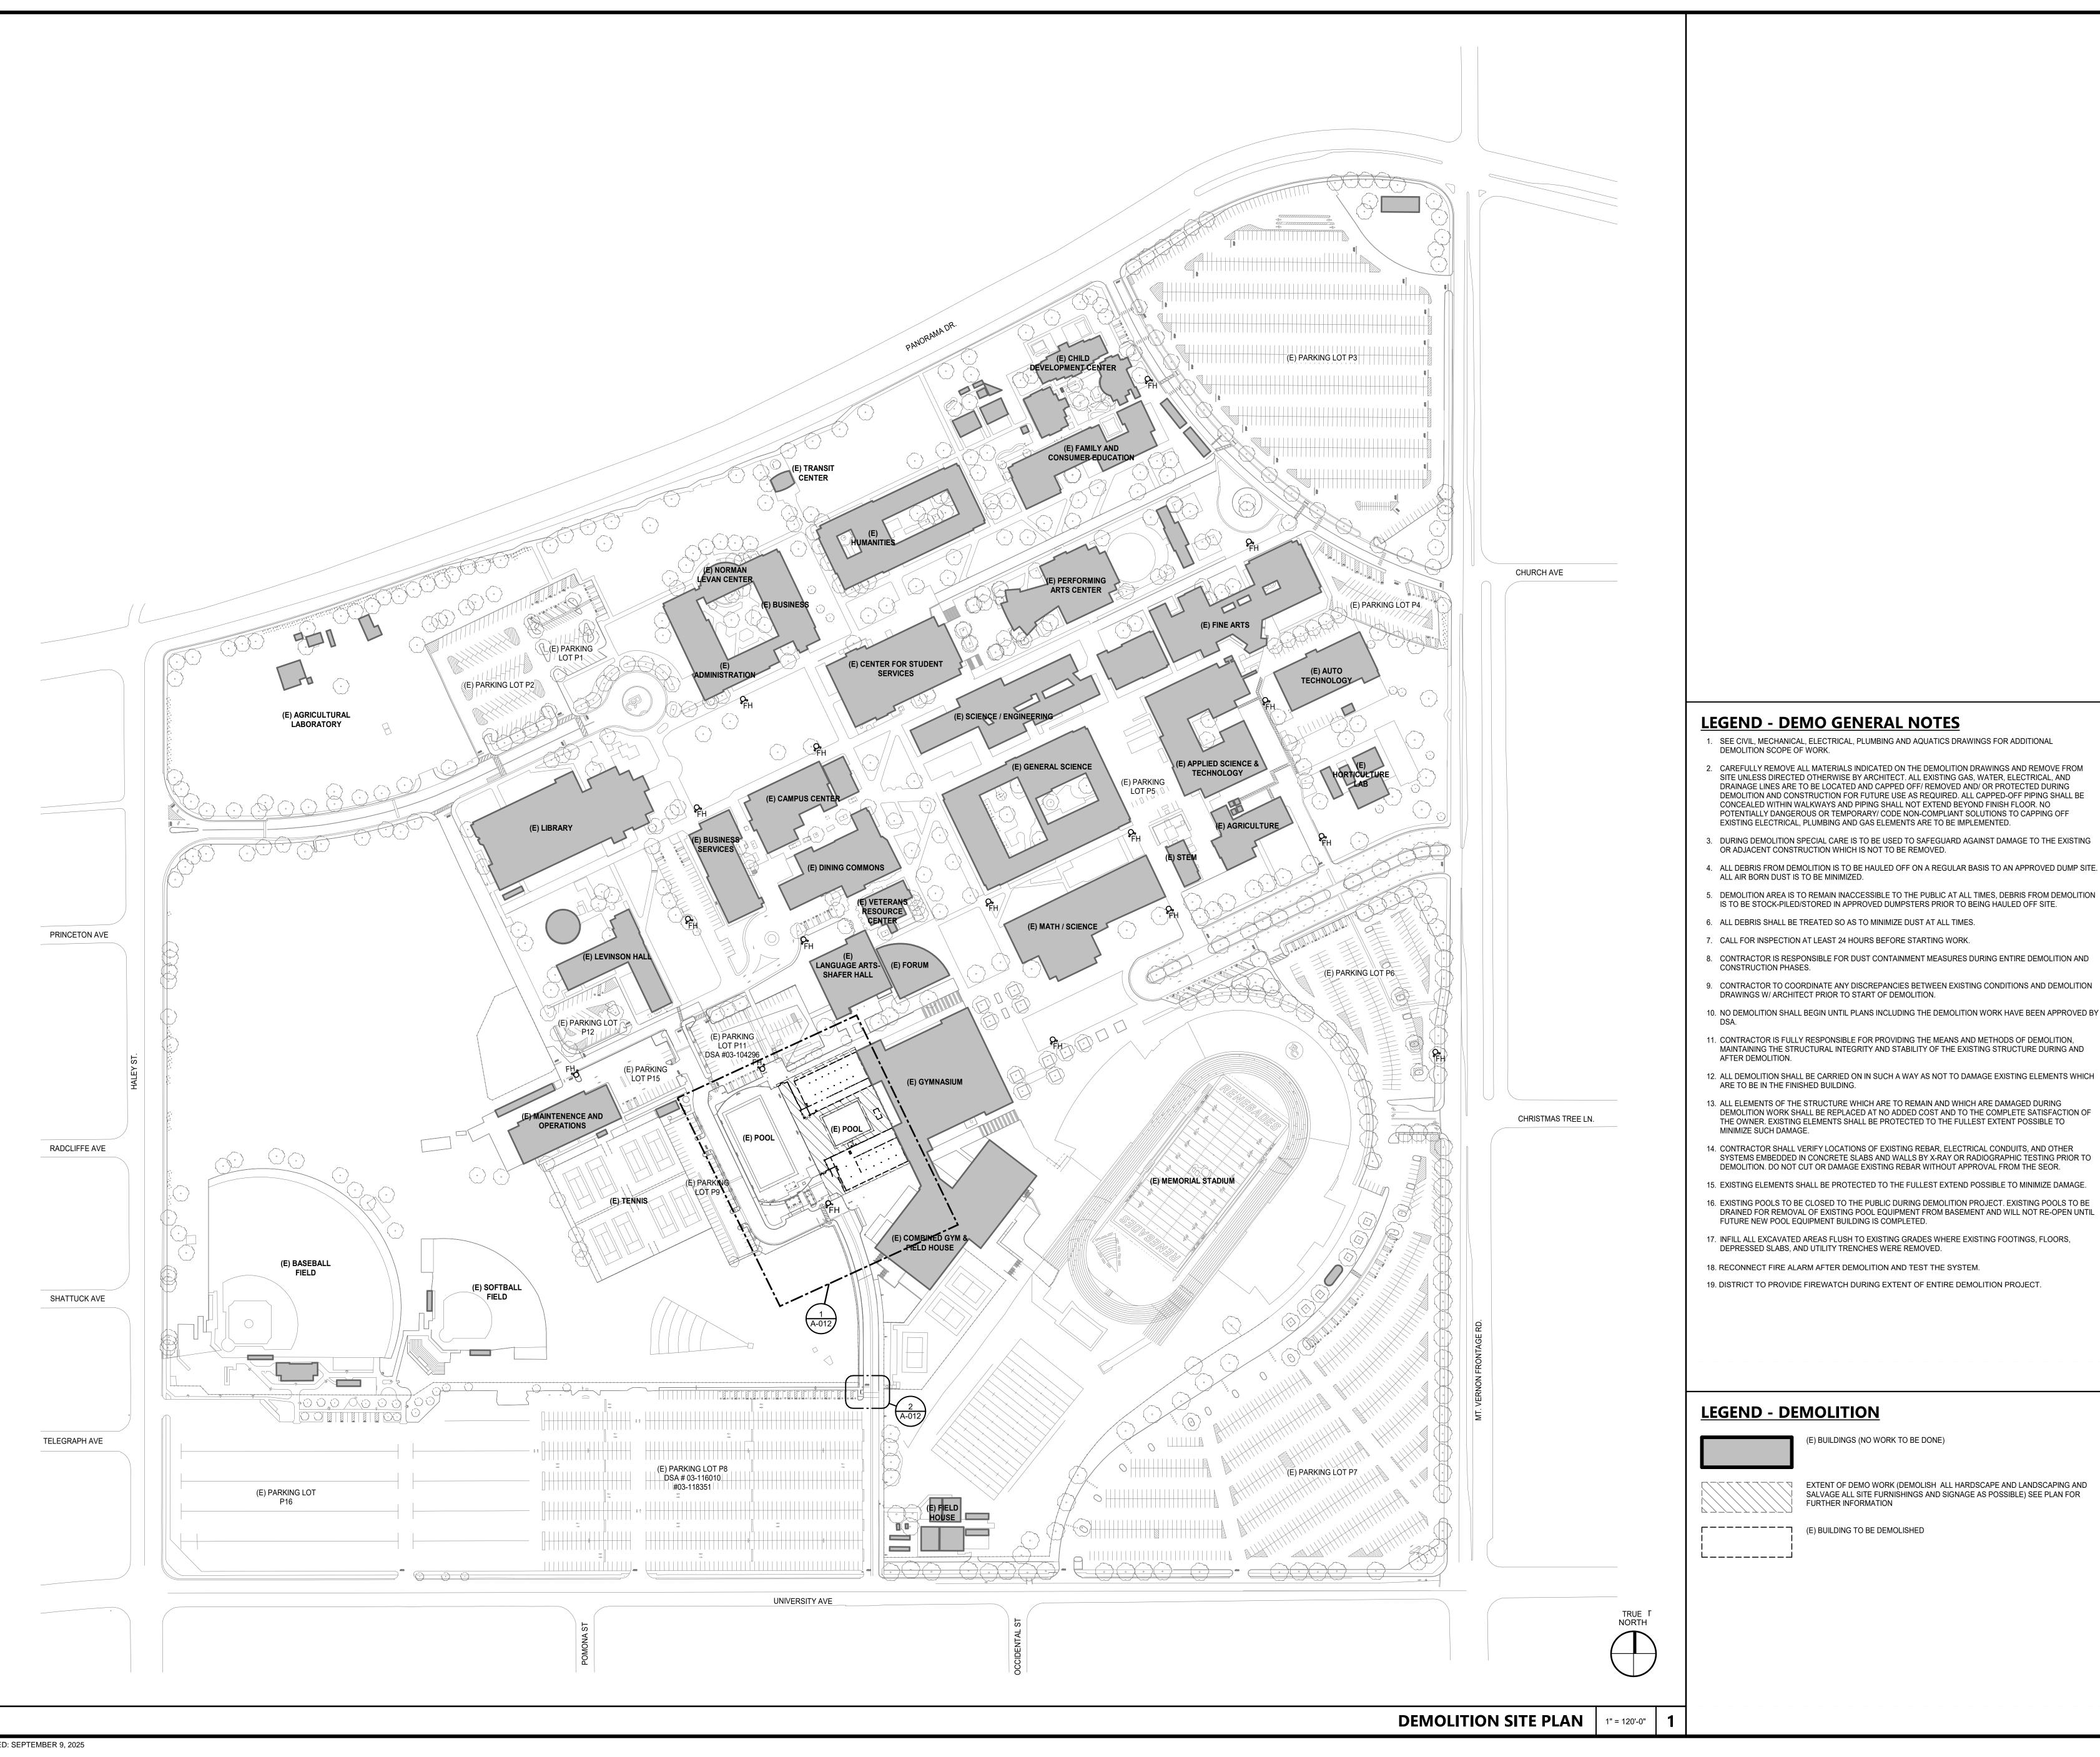

IDENTIFICATION STAMP DIV. OF THE STATE ARCHITE APP: 03-124690 INC: REVIEWED FOR SS 🗹 FLS 🗹 ACS 🗌 DATE: 04/01/2025

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CONSULTANTS

TEL (559) 326-1400

TEL (562) 497-2999

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TEL (562) 497-2999 A Q U A T I C S E N G I N E E R COUNSILMAN-HUNSAKER

Long Beach, CA 90815

12851 Manchester Road, Suite 120 St. Louis, MO 63131 TEL (314) 894-1245

ARCHITECT STAMP

C-22474 REN. 10-31-25

DATE

CONSULTANT STAMP

DESCRIPTION

EXISTING ELECTRICAL, PLUMBING AND GAS ELEMENTS ARE TO BE IMPLEMENTED.

- OR ADJACENT CONSTRUCTION WHICH IS NOT TO BE REMOVED.
- 5. DEMOLITION AREA IS TO REMAIN INACCESSIBLE TO THE PUBLIC AT ALL TIMES, DEBRIS FROM DEMOLITION
- IS TO BE STOCK-PILED/STORED IN APPROVED DUMPSTERS PRIOR TO BEING HAULED OFF SITE.
- 6. ALL DEBRIS SHALL BE TREATED SO AS TO MINIMIZE DUST AT ALL TIMES.
- 7. CALL FOR INSPECTION AT LEAST 24 HOURS BEFORE STARTING WORK.
- 8. CONTRACTOR IS RESPONSIBLE FOR DUST CONTAINMENT MEASURES DURING ENTIRE DEMOLITION AND CONSTRUCTION PHASES.
- 10. NO DEMOLITION SHALL BEGIN UNTIL PLANS INCLUDING THE DEMOLITION WORK HAVE BEEN APPROVED BY
- 11. CONTRACTOR IS FULLY RESPONSIBLE FOR PROVIDING THE MEANS AND METHODS OF DEMOLITION, MAINTAINING THE STRUCTURAL INTEGRITY AND STABILITY OF THE EXISTING STRUCTURE DURING AND
- AFTER DEMOLITION. 12. ALL DEMOLITION SHALL BE CARRIED ON IN SUCH A WAY AS NOT TO DAMAGE EXISTING ELEMENTS WHICH
- 13. ALL ELEMENTS OF THE STRUCTURE WHICH ARE TO REMAIN AND WHICH ARE DAMAGED DURING
- DEMOLITION WORK SHALL BE REPLACED AT NO ADDED COST AND TO THE COMPLETE SATISFACTION OF THE OWNER. EXISTING ELEMENTS SHALL BE PROTECTED TO THE FULLEST EXTENT POSSIBLE TO MINIMIZE SUCH DAMAGE.
- SYSTEMS EMBEDDED IN CONCRETE SLABS AND WALLS BY X-RAY OR RADIOGRAPHIC TESTING PRIOR TO DEMOLITION. DO NOT CUT OR DAMAGE EXISTING REBAR WITHOUT APPROVAL FROM THE SEOR.
- 15. EXISTING ELEMENTS SHALL BE PROTECTED TO THE FULLEST EXTEND POSSIBLE TO MINIMIZE DAMAGE.
- 16. EXISTING POOLS TO BE CLOSED TO THE PUBLIC DURING DEMOLITION PROJECT. EXISTING POOLS TO BE DRAINED FOR REMOVAL OF EXISTING POOL EQUIPMENT FROM BASEMENT AND WILL NOT RE-OPEN UNTIL FUTURE NEW POOL EQUIPMENT BUILDING IS COMPLETED.
- 17. INFILL ALL EXCAVATED AREAS FLUSH TO EXISTING GRADES WHERE EXISTING FOOTINGS, FLOORS, DEPRESSED SLABS, AND UTILITY TRENCHES WERE REMOVED.
- 18. RECONNECT FIRE ALARM AFTER DEMOLITION AND TEST THE SYSTEM.
- 19. DISTRICT TO PROVIDE FIREWATCH DURING EXTENT OF ENTIRE DEMOLITION PROJECT.

(E) BUILDINGS (NO WORK TO BE DONE)

FURTHER INFORMATION

EXTENT OF DEMO WORK (DEMOLISH ALL HARDSCAPE AND LANDSCAPING AND SALVAGE ALL SITE FURNISHINGS AND SIGNAGE AS POSSIBLE) SEE PLAN FOR

THESE PLANS OR THE SPECIFICATIONS ARE SUITABLE FOR ANY SITE OTHER THAN THE ONE FOR WHICH THEY WERE SPECIFICALLY PREPARED. THE ARCHITECT DISCLAIMS RESPONSIBILITY FOR THESE PLANS AND

THE ARCHITECT DOES NOT REPRESENT THAT

SPECIFICATIONS IF THEY ARE USED IN WHOLE OR IN PART AT ANY OTHER SITE. WRITTEN DIMENSIONS ON THESE DRAWINGS SHALL HAVE PRECEDENCE OVER SCALED DIMENSIONS.


PROJECT OWNER & TITLE KERN COMMUNITY COLLEGE DISTRICT 1801 Panorama Dr.

Bakersfield, CA 93305

Bakersfield College **Pool Building and Site Demolition**

DEMOLITION SITE PLAN

DRAWN BY: Author JOB NUMBER: 23024.01

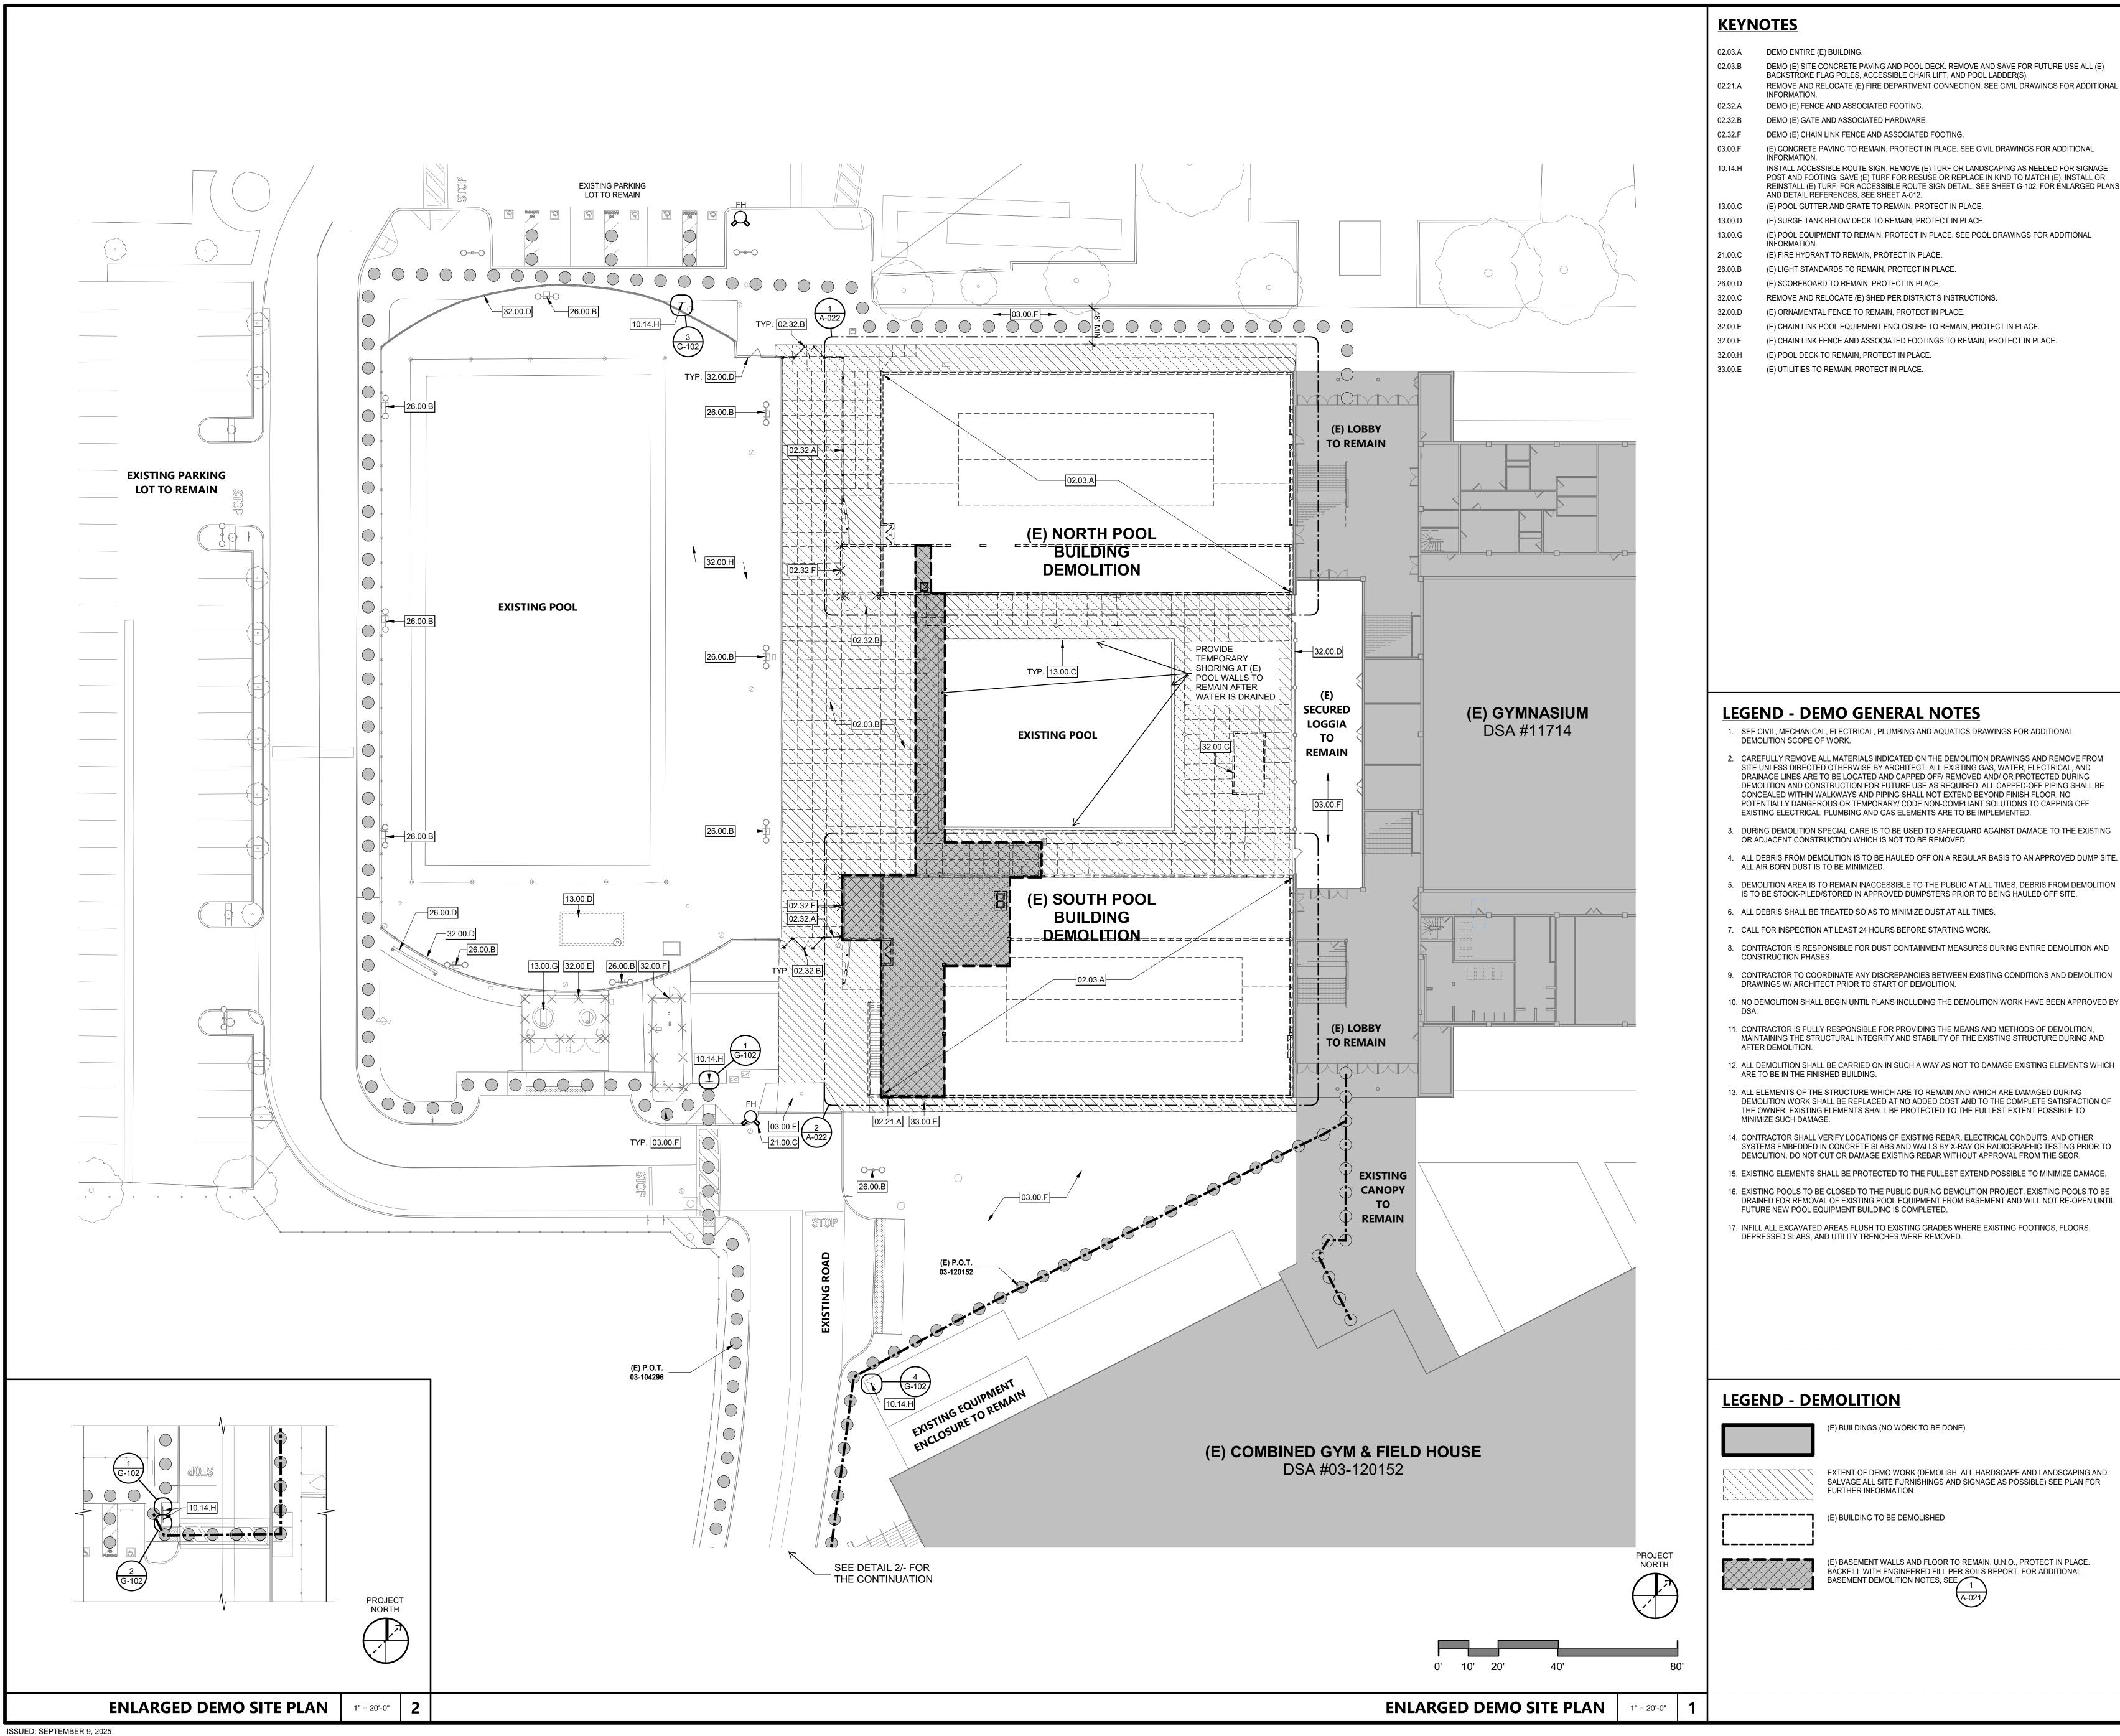

DEMO (E) SITE CONCRETE PAVING AND POOL DECK. REMOVE AND SAVE FOR FUTURE USE ALL (E)

REMOVE AND RELOCATE (E) FIRE DEPARTMENT CONNECTION. SEE CIVIL DRAWINGS FOR ADDITIONAL INFORMATION.

DEMO (E) FENCE AND ASSOCIATED FOOTING.

DEMO (E) GATE AND ASSOCIATED HARDWARE.

DEMO (E) CHAIN LINK FENCE AND ASSOCIATED FOOTING.

(E) CONCRETE PAVING TO REMAIN, PROTECT IN PLACE. SEE CIVIL DRAWINGS FOR ADDITIONAL INSTALL ACCESSIBLE ROUTE SIGN. REMOVE (E) TURF OR LANDSCAPING AS NEEDED FOR SIGNAGE POST AND FOOTING. SAVE (E) TURF FOR RESUSE OR REPLACE IN KIND TO MATCH (E). INSTALL OR

(E) POOL GUTTER AND GRATE TO REMAIN, PROTECT IN PLACE.

(E) SURGE TANK BELOW DECK TO REMAIN, PROTECT IN PLACE. (E) POOL EQUIPMENT TO REMAIN, PROTECT IN PLACE. SEE POOL DRAWINGS FOR ADDITIONAL

(E) FIRE HYDRANT TO REMAIN, PROTECT IN PLACE.

(E) LIGHT STANDARDS TO REMAIN, PROTECT IN PLACE.

(E) SCOREBOARD TO REMAIN, PROTECT IN PLACE.

REMOVE AND RELOCATE (E) SHED PER DISTRICT'S INSTRUCTIONS. (E) ORNAMENTAL FENCE TO REMAIN, PROTECT IN PLACE.

(E) CHAIN LINK POOL EQUIPMENT ENCLOSURE TO REMAIN, PROTECT IN PLACE.

(E) CHAIN LINK FENCE AND ASSOCIATED FOOTINGS TO REMAIN, PROTECT IN PLACE.

(E) POOL DECK TO REMAIN, PROTECT IN PLACE.

33.00.E (E) UTILITIES TO REMAIN, PROTECT IN PLACE.

AGENCY APPROVAL <u>DSA#</u> 03-124690

IDENTIFICATION STAMP

REVIEWED FOR

SS 🗹 FLS 🗹 ACS 🗌

DIV. OF THE STATE ARCHITE

APP: 03-124690 INC:

DATE: 04/01/2025

802 EAST COTA STREET, SUITE A SANTA BARBARA, CA 93103 TEL (805) 963-1955

CONSULTANTS

TEL (559) 326-1400

TEL (562) 497-2999

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TEL (314) 894-1245

<u>CIVIL ENGINEER</u> BLAIR, CHURCH, & FLYNN 451 Clovis Avenue Clovis, CA 93612

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<u>AQUATICS ENGINEER</u> COUNSILMAN-HUNSAKER 12851 Manchester Road, Suite 120 St. Louis, MO 63131

- . SEE CIVIL, MECHANICAL, ELECTRICAL, PLUMBING AND AQUATICS DRAWINGS FOR ADDITIONAL DEMOLITION SCOPE OF WORK.
- CAREFULLY REMOVE ALL MATERIALS INDICATED ON THE DEMOLITION DRAWINGS AND REMOVE FROM DRAINAGE LINES ARE TO BE LOCATED AND CAPPED OFF/ REMOVED AND/ OR PROTECTED DURING DEMOLITION AND CONSTRUCTION FOR FUTURE USE AS REQUIRED. ALL CAPPED-OFF PIPING SHALL BE CONCEALED WITHIN WALKWAYS AND PIPING SHALL NOT EXTEND BEYOND FINISH FLOOR. NO POTENTIALLY DANGEROUS OR TEMPORARY/ CODE NON-COMPLIANT SOLUTIONS TO CAPPING OFF EXISTING ELECTRICAL, PLUMBING AND GAS ELEMENTS ARE TO BE IMPLEMENTED.
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- 5. DEMOLITION AREA IS TO REMAIN INACCESSIBLE TO THE PUBLIC AT ALL TIMES, DEBRIS FROM DEMOLITION IS TO BE STOCK-PILED/STORED IN APPROVED DUMPSTERS PRIOR TO BEING HAULED OFF SITE.
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- 8. CONTRACTOR IS RESPONSIBLE FOR DUST CONTAINMENT MEASURES DURING ENTIRE DEMOLITION AND CONSTRUCTION PHASES.
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- 17. INFILL ALL EXCAVATED AREAS FLUSH TO EXISTING GRADES WHERE EXISTING FOOTINGS, FLOORS,

(E) BUILDINGS (NO WORK TO BE DONE)

BASEMENT DEMOLITION NOTES, SEE 1

FURTHER INFORMATION

EXTENT OF DEMO WORK (DEMOLISH ALL HARDSCAPE AND LANDSCAPING AND SALVAGE ALL SITE FURNISHINGS AND SIGNAGE AS POSSIBLE) SEE PLAN FOR

(E) BASEMENT WALLS AND FLOOR TO REMAIN, U.N.O., PROTECT IN PLACE.

BACKFILL WITH ENGINEERED FILL PER SOILS REPORT. FOR ADDITIONAL

ARCHITECT STAMP CENSEL ARCHITECT ARCHITECT STAMP CENSEL ARCHITECT ARCHITECT STAMP CONSULTANT STAMP		
* Alex Socle * C-22474		CONSULTANT STAMP
OF CALIF	* C-22474 OF CALIFORNIA ** ** ** ** ** ** ** ** **	

REVISIONS DATE DESCRIPTION

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PROJECT OWNER & TITLE KERN COMMUNITY COLLEGE DISTRICT

1801 Panorama Dr. Bakersfield, CA 93305

Bakersfield College


Pool Building and Site Demolition


ENLARGED **DEMOLITION SITE**

PLAN

DRAWN BY: Author JOB NUMBER: 23024.01

A-012

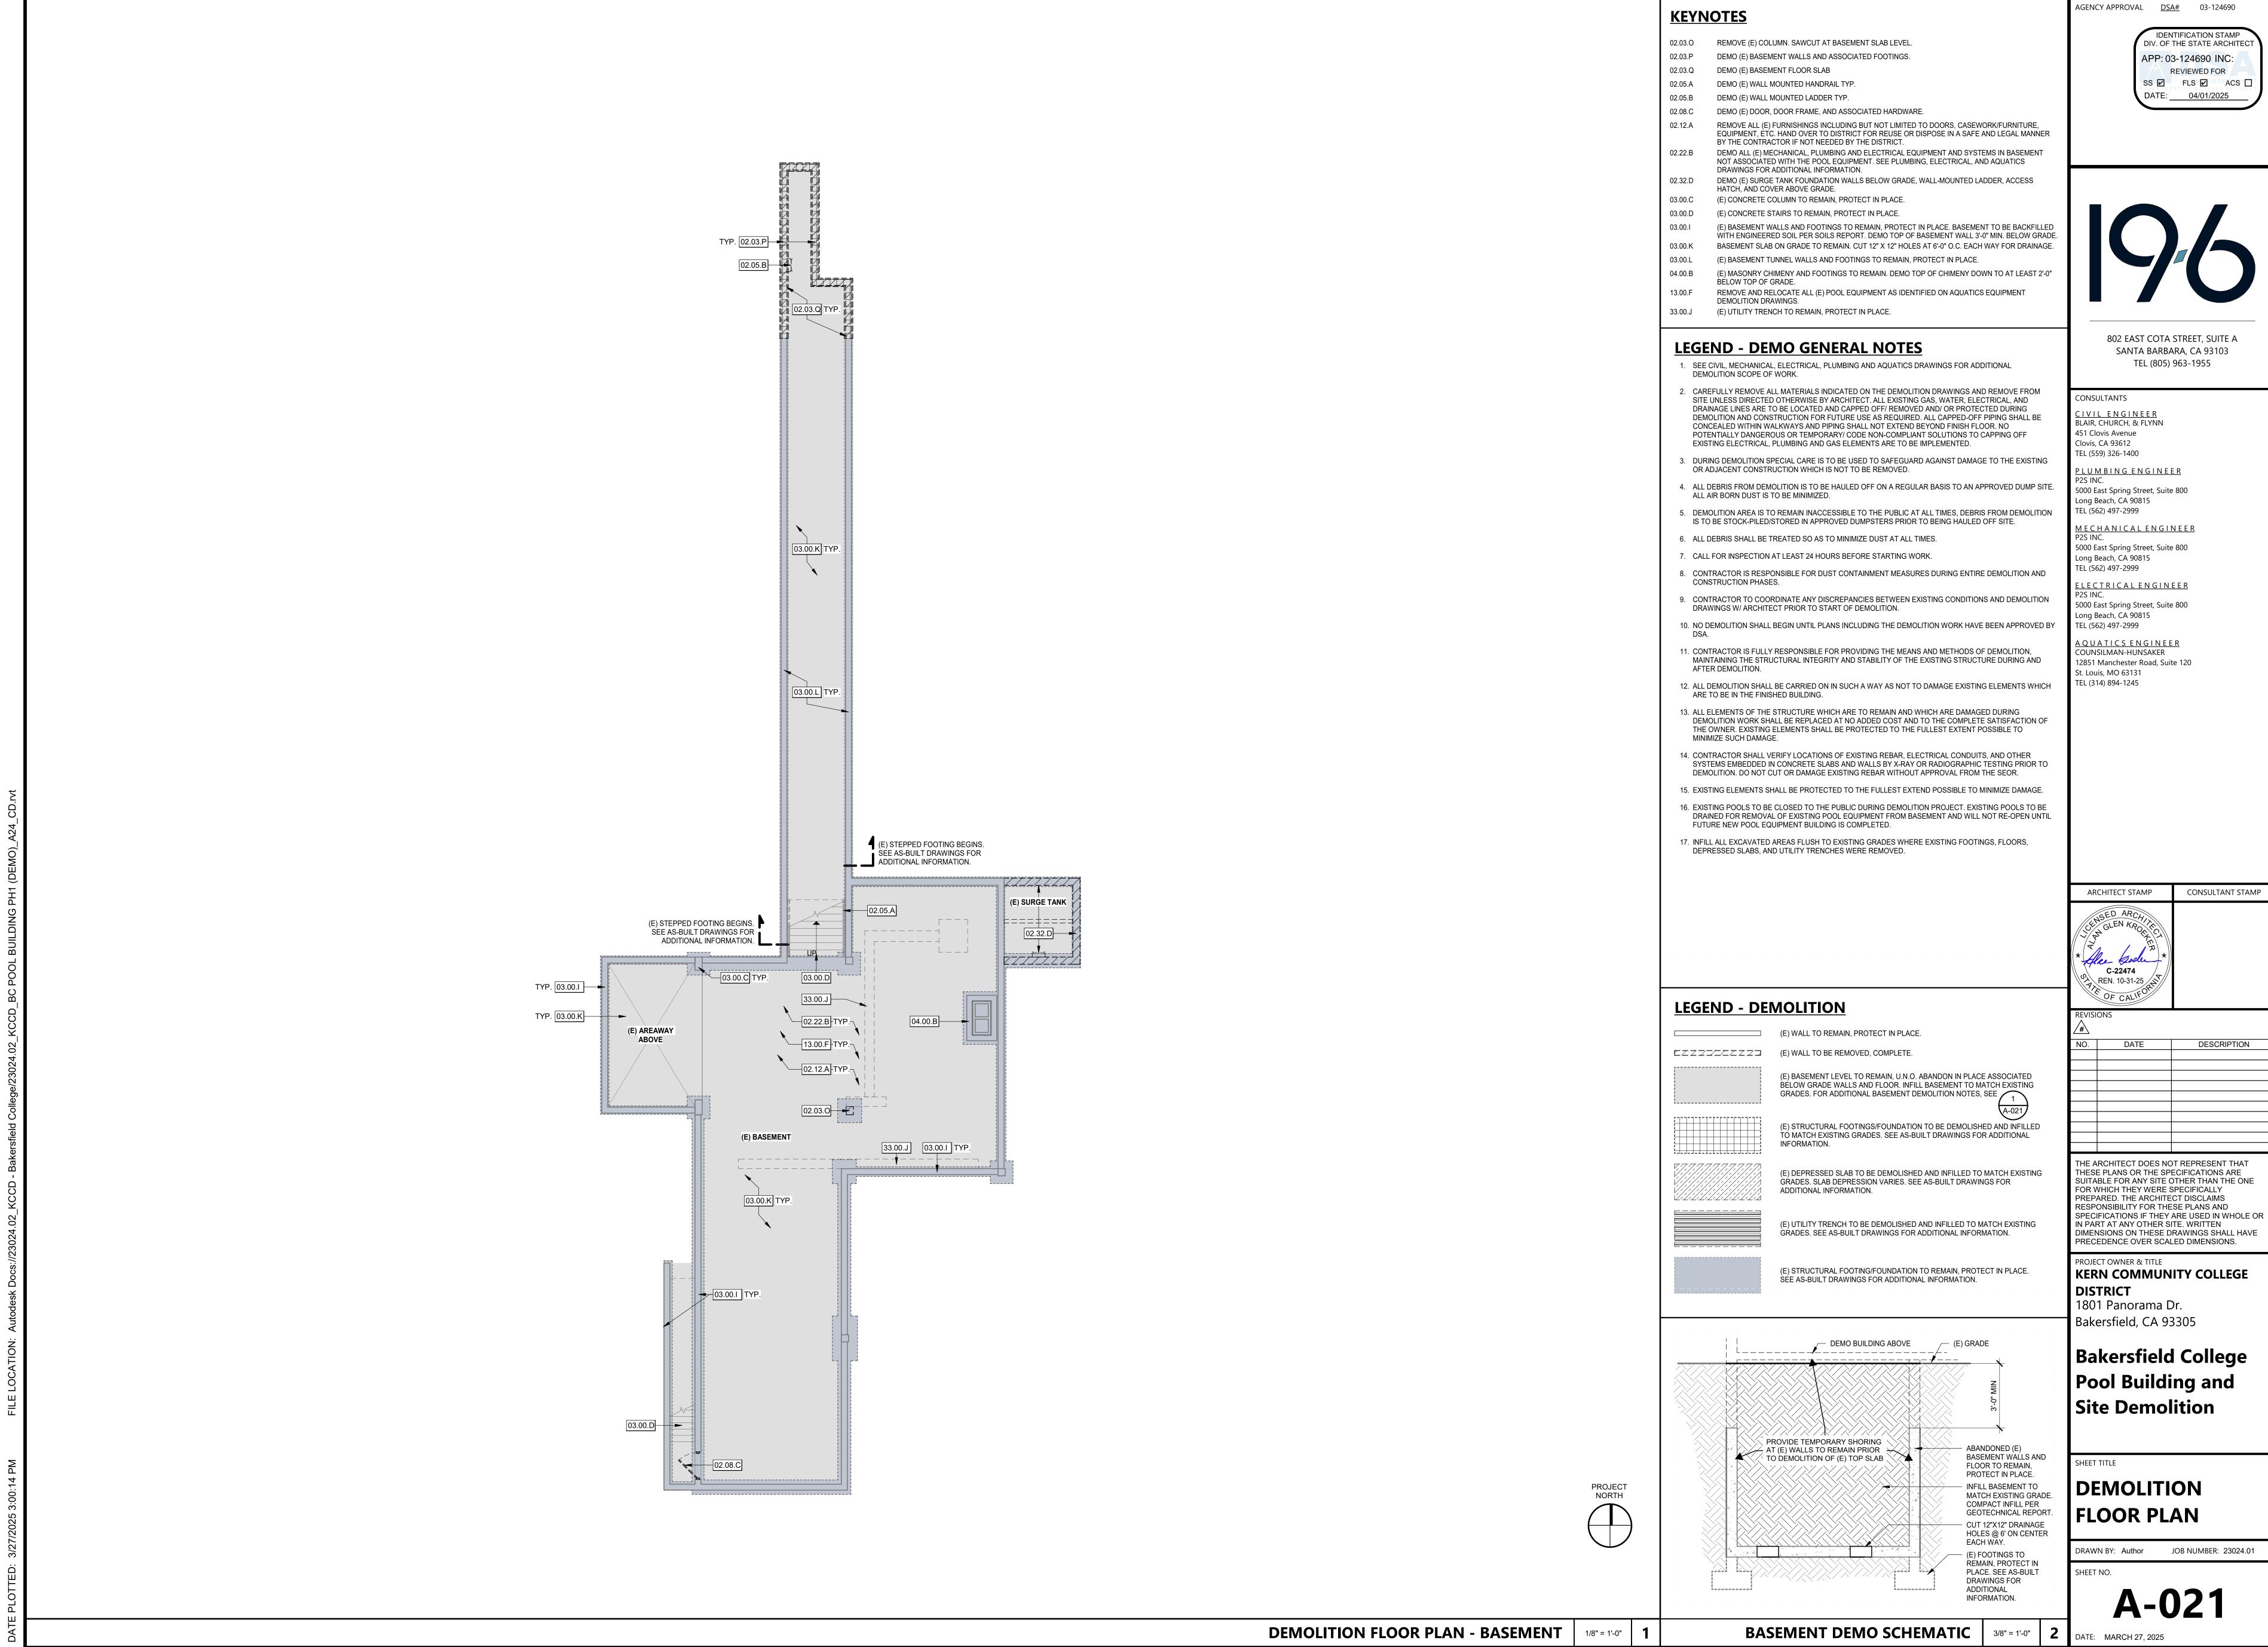

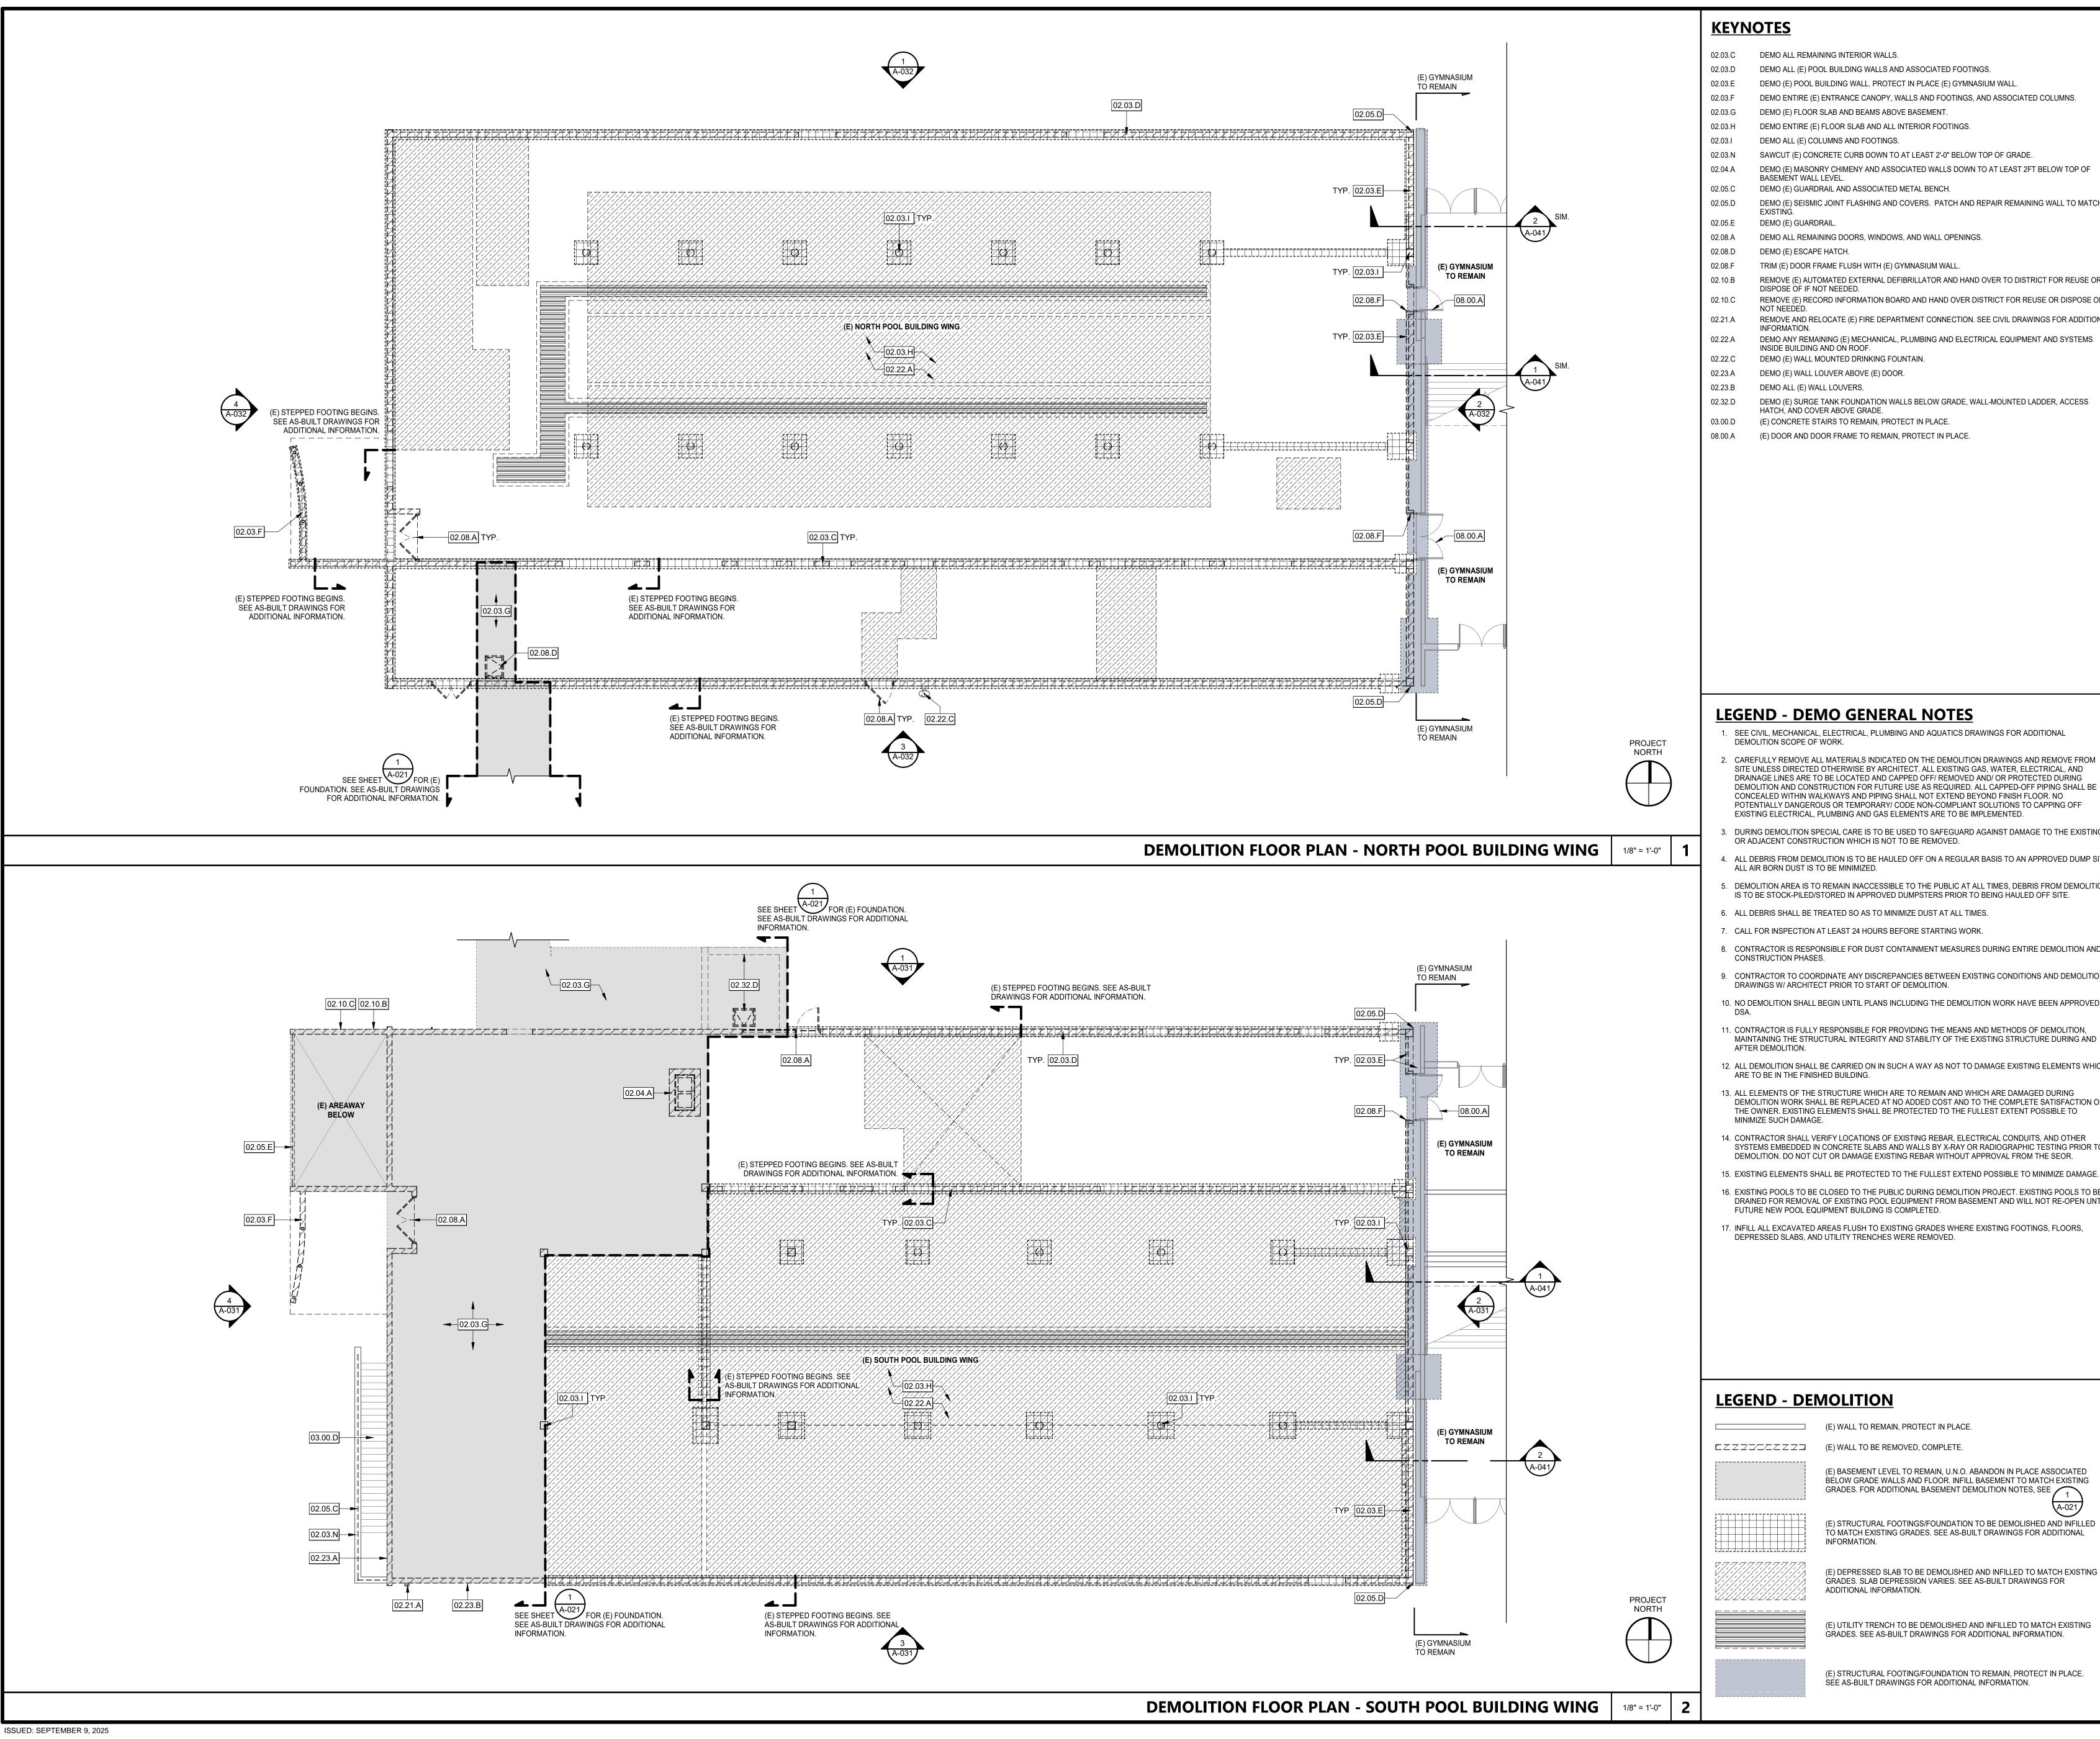

02.03.C DEMO ALL REMAINING INTERIOR WALLS. DEMO ALL (E) POOL BUILDING WALLS AND ASSOCIATED FOOTINGS.

DEMO (E) POOL BUILDING WALL. PROTECT IN PLACE (E) GYMNASIUM WALL.

DEMO ENTIRE (E) ENTRANCE CANOPY, WALLS AND FOOTINGS, AND ASSOCIATED COLUMNS.

DEMO (E) FLOOR SLAB AND BEAMS ABOVE BASEMENT.

DEMO ALL (E) COLUMNS AND FOOTINGS.

SAWCUT (E) CONCRETE CURB DOWN TO AT LEAST 2'-0" BELOW TOP OF GRADE. DEMO (E) MASONRY CHIMENY AND ASSOCIATED WALLS DOWN TO AT LEAST 2FT BELOW TOP OF

BASEMENT WALL LEVEL.

DEMO (E) GUARDRAIL AND ASSOCIATED METAL BENCH. DEMO (E) SEISMIC JOINT FLASHING AND COVERS. PATCH AND REPAIR REMAINING WALL TO MATCH

DEMO (E) GUARDRAIL.

DEMO ALL REMAINING DOORS, WINDOWS, AND WALL OPENINGS.

TRIM (E) DOOR FRAME FLUSH WITH (E) GYMNASIUM WALL.

REMOVE (E) AUTOMATED EXTERNAL DEFIBRILLATOR AND HAND OVER TO DISTRICT FOR REUSE OR

REMOVE (E) RECORD INFORMATION BOARD AND HAND OVER DISTRICT FOR REUSE OR DISPOSE OF IF REMOVE AND RELOCATE (E) FIRE DEPARTMENT CONNECTION. SEE CIVIL DRAWINGS FOR ADDITIONAL

DEMO ANY REMAINING (E) MECHANICAL, PLUMBING AND ELECTRICAL EQUIPMENT AND SYSTEMS

DEMO (E) WALL MOUNTED DRINKING FOUNTAIN.

DEMO (E) WALL LOUVER ABOVE (E) DOOR.

DEMO ALL (E) WALL LOUVERS.

DEMO (E) SURGE TANK FOUNDATION WALLS BELOW GRADE, WALL-MOUNTED LADDER, ACCESS

(E) CONCRETE STAIRS TO REMAIN, PROTECT IN PLACE.

(E) DOOR AND DOOR FRAME TO REMAIN, PROTECT IN PLACE.

AGENCY APPROVAL <u>DSA#</u> 03-124690

IDENTIFICATION STAMP

REVIEWED FOR

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DIV. OF THE STATE ARCHITE

APP: 03-124690 INC:

DATE: 04/01/2025

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TEL (559) 326-1400

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<u>AQUATICS ENGINEER</u> COUNSILMAN-HUNSAKER 12851 Manchester Road, Suite 120 St. Louis, MO 63131 TEL (314) 894-1245

LEGEND - DEMO GENERAL NOTES

- . SEE CIVIL, MECHANICAL, ELECTRICAL, PLUMBING AND AQUATICS DRAWINGS FOR ADDITIONAL
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- 17. INFILL ALL EXCAVATED AREAS FLUSH TO EXISTING GRADES WHERE EXISTING FOOTINGS, FLOORS, DEPRESSED SLABS, AND UTILITY TRENCHES WERE REMOVED.

ARCHITECT STAMP	CONSULTANT STAMP
* Alex Sole * C-22474 REN. 10-31-25 PTE OF CALIFORN C-ALIFORN REN. 10-31-25	

DATE DESCRIPTION

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PROJECT OWNER & TITLE KERN COMMUNITY COLLEGE DISTRICT

1801 Panorama Dr. Bakersfield, CA 93305

Site Demolition


Bakersfield College Pool Building and

DEMOLITION FLOOR PLANS

DRAWN BY: Author JOB NUMBER: 23024.01

A-022

DATE: MARCH 27, 2025

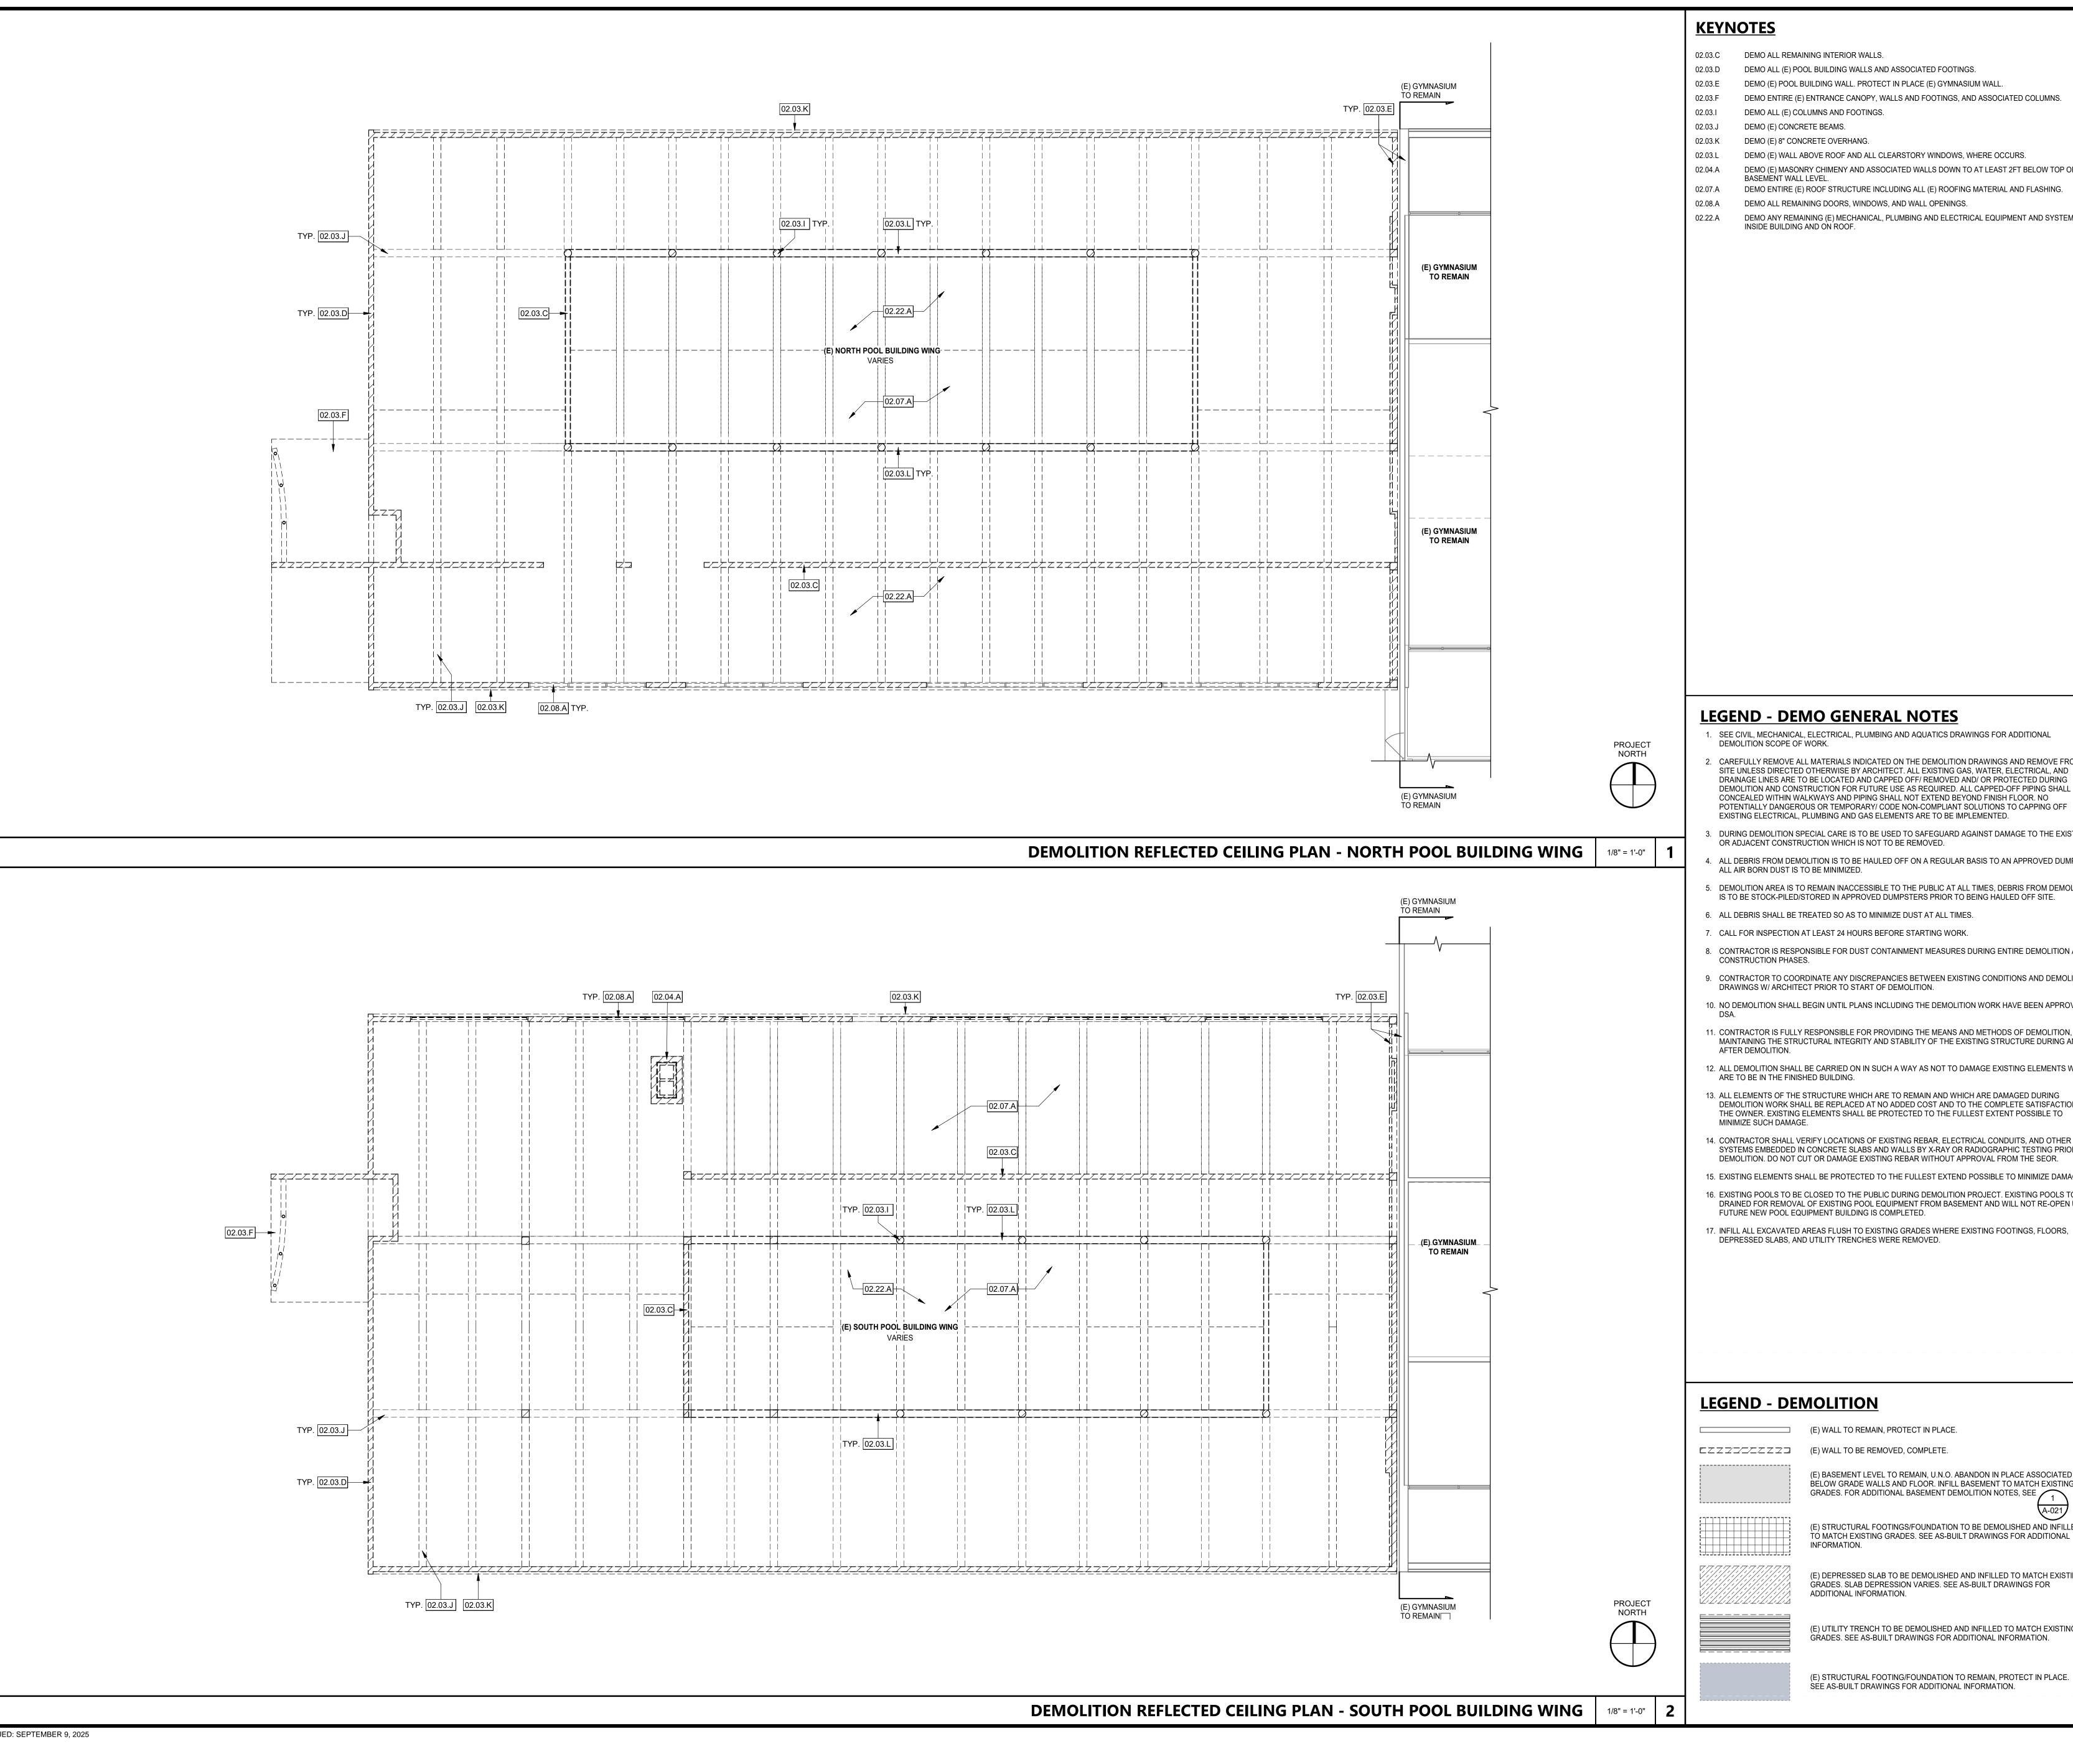

- 02.03.C DEMO ALL REMAINING INTERIOR WALLS.
- DEMO ALL (E) POOL BUILDING WALLS AND ASSOCIATED FOOTINGS
- DEMO (E) POOL BUILDING WALL. PROTECT IN PLACE (E) GYMNASIUM WALL.
- DEMO ENTIRE (E) ENTRANCE CANOPY, WALLS AND FOOTINGS, AND ASSOCIATED COLUMNS. DEMO ALL (E) COLUMNS AND FOOTINGS.
- DEMO (E) CONCRETE BEAMS.
- DEMO (E) 8" CONCRETE OVERHANG.
- DEMO (E) WALL ABOVE ROOF AND ALL CLEARSTORY WINDOWS, WHERE OCCURS.
- DEMO (E) MASONRY CHIMENY AND ASSOCIATED WALLS DOWN TO AT LEAST 2FT BELOW TOP OF BASEMENT WALL LEVEL.
- DEMO ENTIRE (E) ROOF STRUCTURE INCLUDING ALL (E) ROOFING MATERIAL AND FLASHING. DEMO ALL REMAINING DOORS, WINDOWS, AND WALL OPENINGS.
- DEMO ANY REMAINING (E) MECHANICAL, PLUMBING AND ELECTRICAL EQUIPMENT AND SYSTEMS INSIDE BUILDING AND ON ROOF.

DATE: 04/01/2025

IDENTIFICATION STAMP

REVIEWED FOR

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DIV. OF THE STATE ARCHITE

APP: 03-124690 INC:

AGENCY APPROVAL <u>DSA#</u>

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TEL (559) 326-1400

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MECHANICAL ENGINEER 5000 East Spring Street, Suite 800 Long Beach, CA 90815

TEL (562) 497-2999 <u>ELECTRICAL ENGINEER</u> 5000 East Spring Street, Suite 800

AQUATICS ENGINEER COUNSILMAN-HUNSAKER 12851 Manchester Road, Suite 120 St. Louis, MO 63131

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(E) WALL TO REMAIN, PROTECT IN PLACE

INFORMATION.

ADDITIONAL INFORMATION.

(E) BASEMENT LEVEL TO REMAIN, U.N.O. ABANDON IN PLACE ASSOCIATED BELOW GRADE WALLS AND FLOOR. INFILL BASEMENT TO MATCH EXISTING GRADES. FOR ADDITIONAL BASEMENT DEMOLITION NOTES, SEE

(E) STRUCTURAL FOOTINGS/FOUNDATION TO BE DEMOLISHED AND INFILLED TO MATCH EXISTING GRADES. SEE AS-BUILT DRAWINGS FOR ADDITIONAL

(E) DEPRESSED SLAB TO BE DEMOLISHED AND INFILLED TO MATCH EXISTING

(E) UTILITY TRENCH TO BE DEMOLISHED AND INFILLED TO MATCH EXISTING GRADES. SEE AS-BUILT DRAWINGS FOR ADDITIONAL INFORMATION.

(E) STRUCTURAL FOOTING/FOUNDATION TO REMAIN, PROTECT IN PLACE.

SEE AS-BUILT DRAWINGS FOR ADDITIONAL INFORMATION.

GRADES, SLAB DEPRESSION VARIES, SEE AS-BUILT DRAWINGS FOR

ARCHITECT STAMP	CONSULTANT STAME
* Alex Sole * C-22474 REN. 10-31-25 PTE OF CALIFORNIA	

REVISIONS

DATE DESCRIPTION

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PROJECT OWNER & TITLE KERN COMMUNITY COLLEGE DISTRICT

1801 Panorama Dr. Bakersfield, CA 93305


Bakersfield College

Pool Building and Site Demolition

DEMO REFLECTED **CEILING PLANS**

DRAWN BY: Author JOB NUMBER: 23024.01


A-023

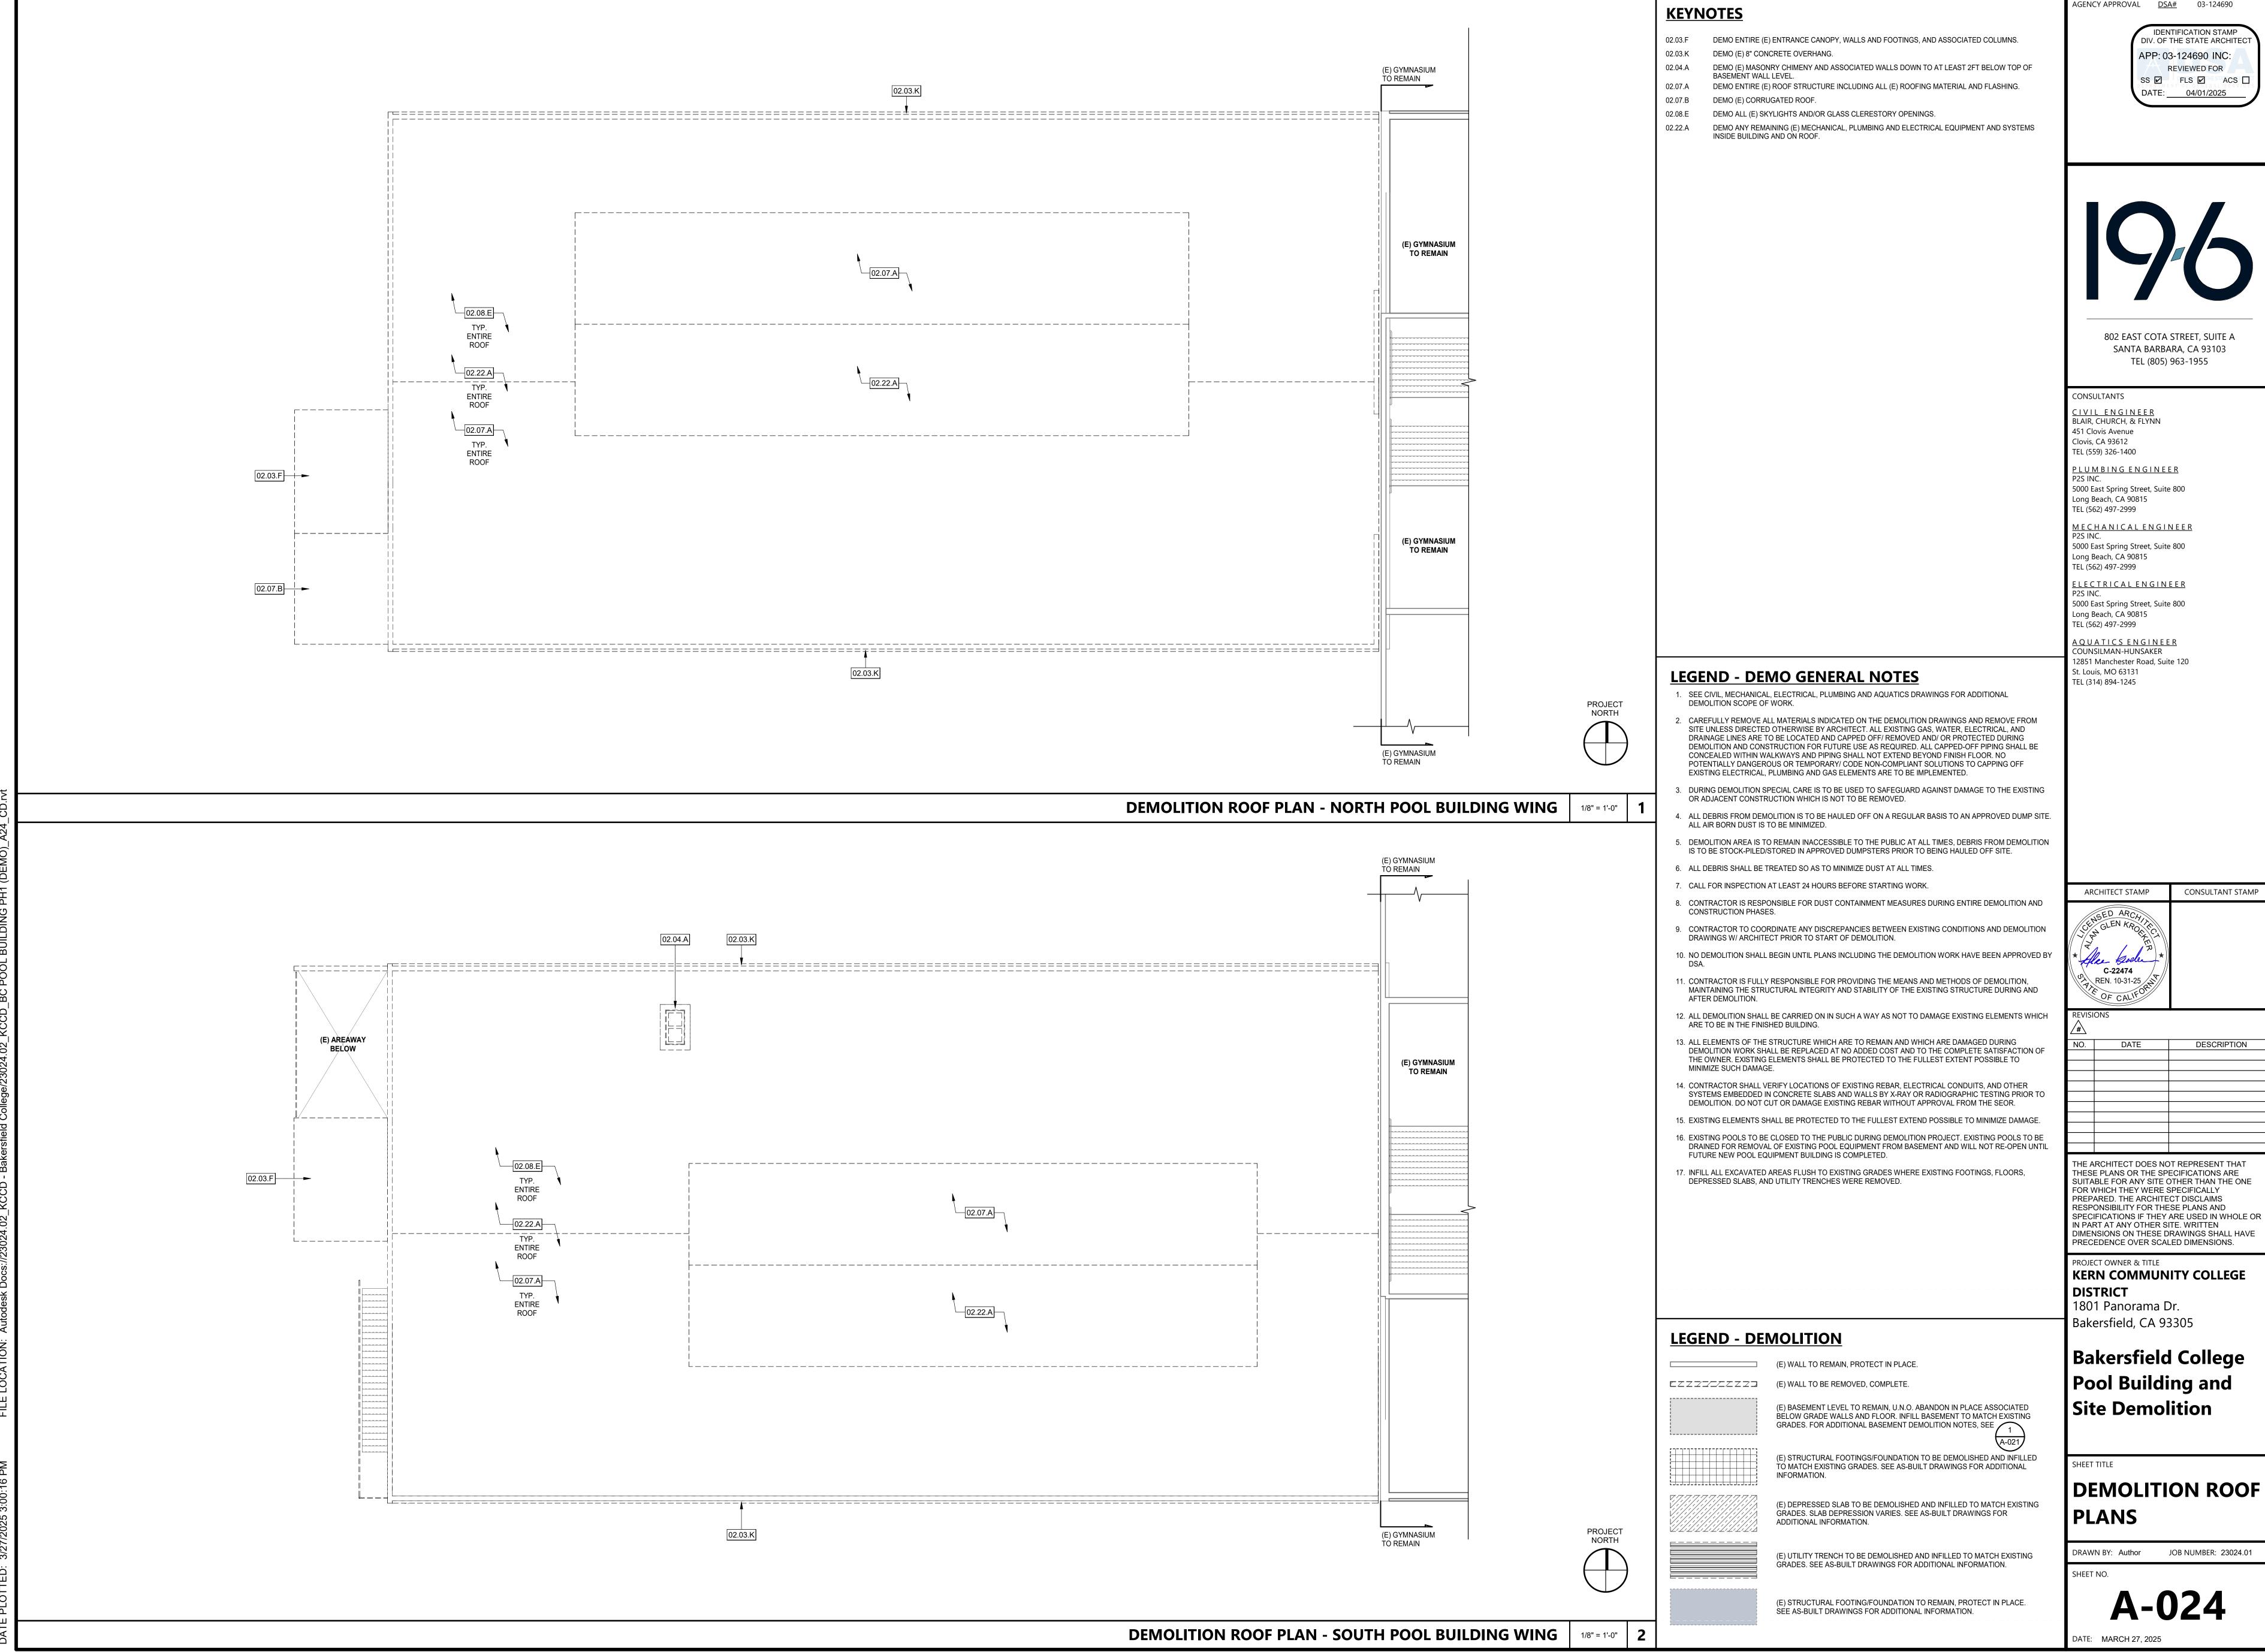

ISSUED: SEPTEMBER 9, 2025

AGENCY APPROVAL <u>DSA#</u> 03-124690

ARCHITECT STAMP	CONSULTANT STAMP
* Alex Socie * C-22474 REN. 10-31-25 PTE OF CALIFOR	

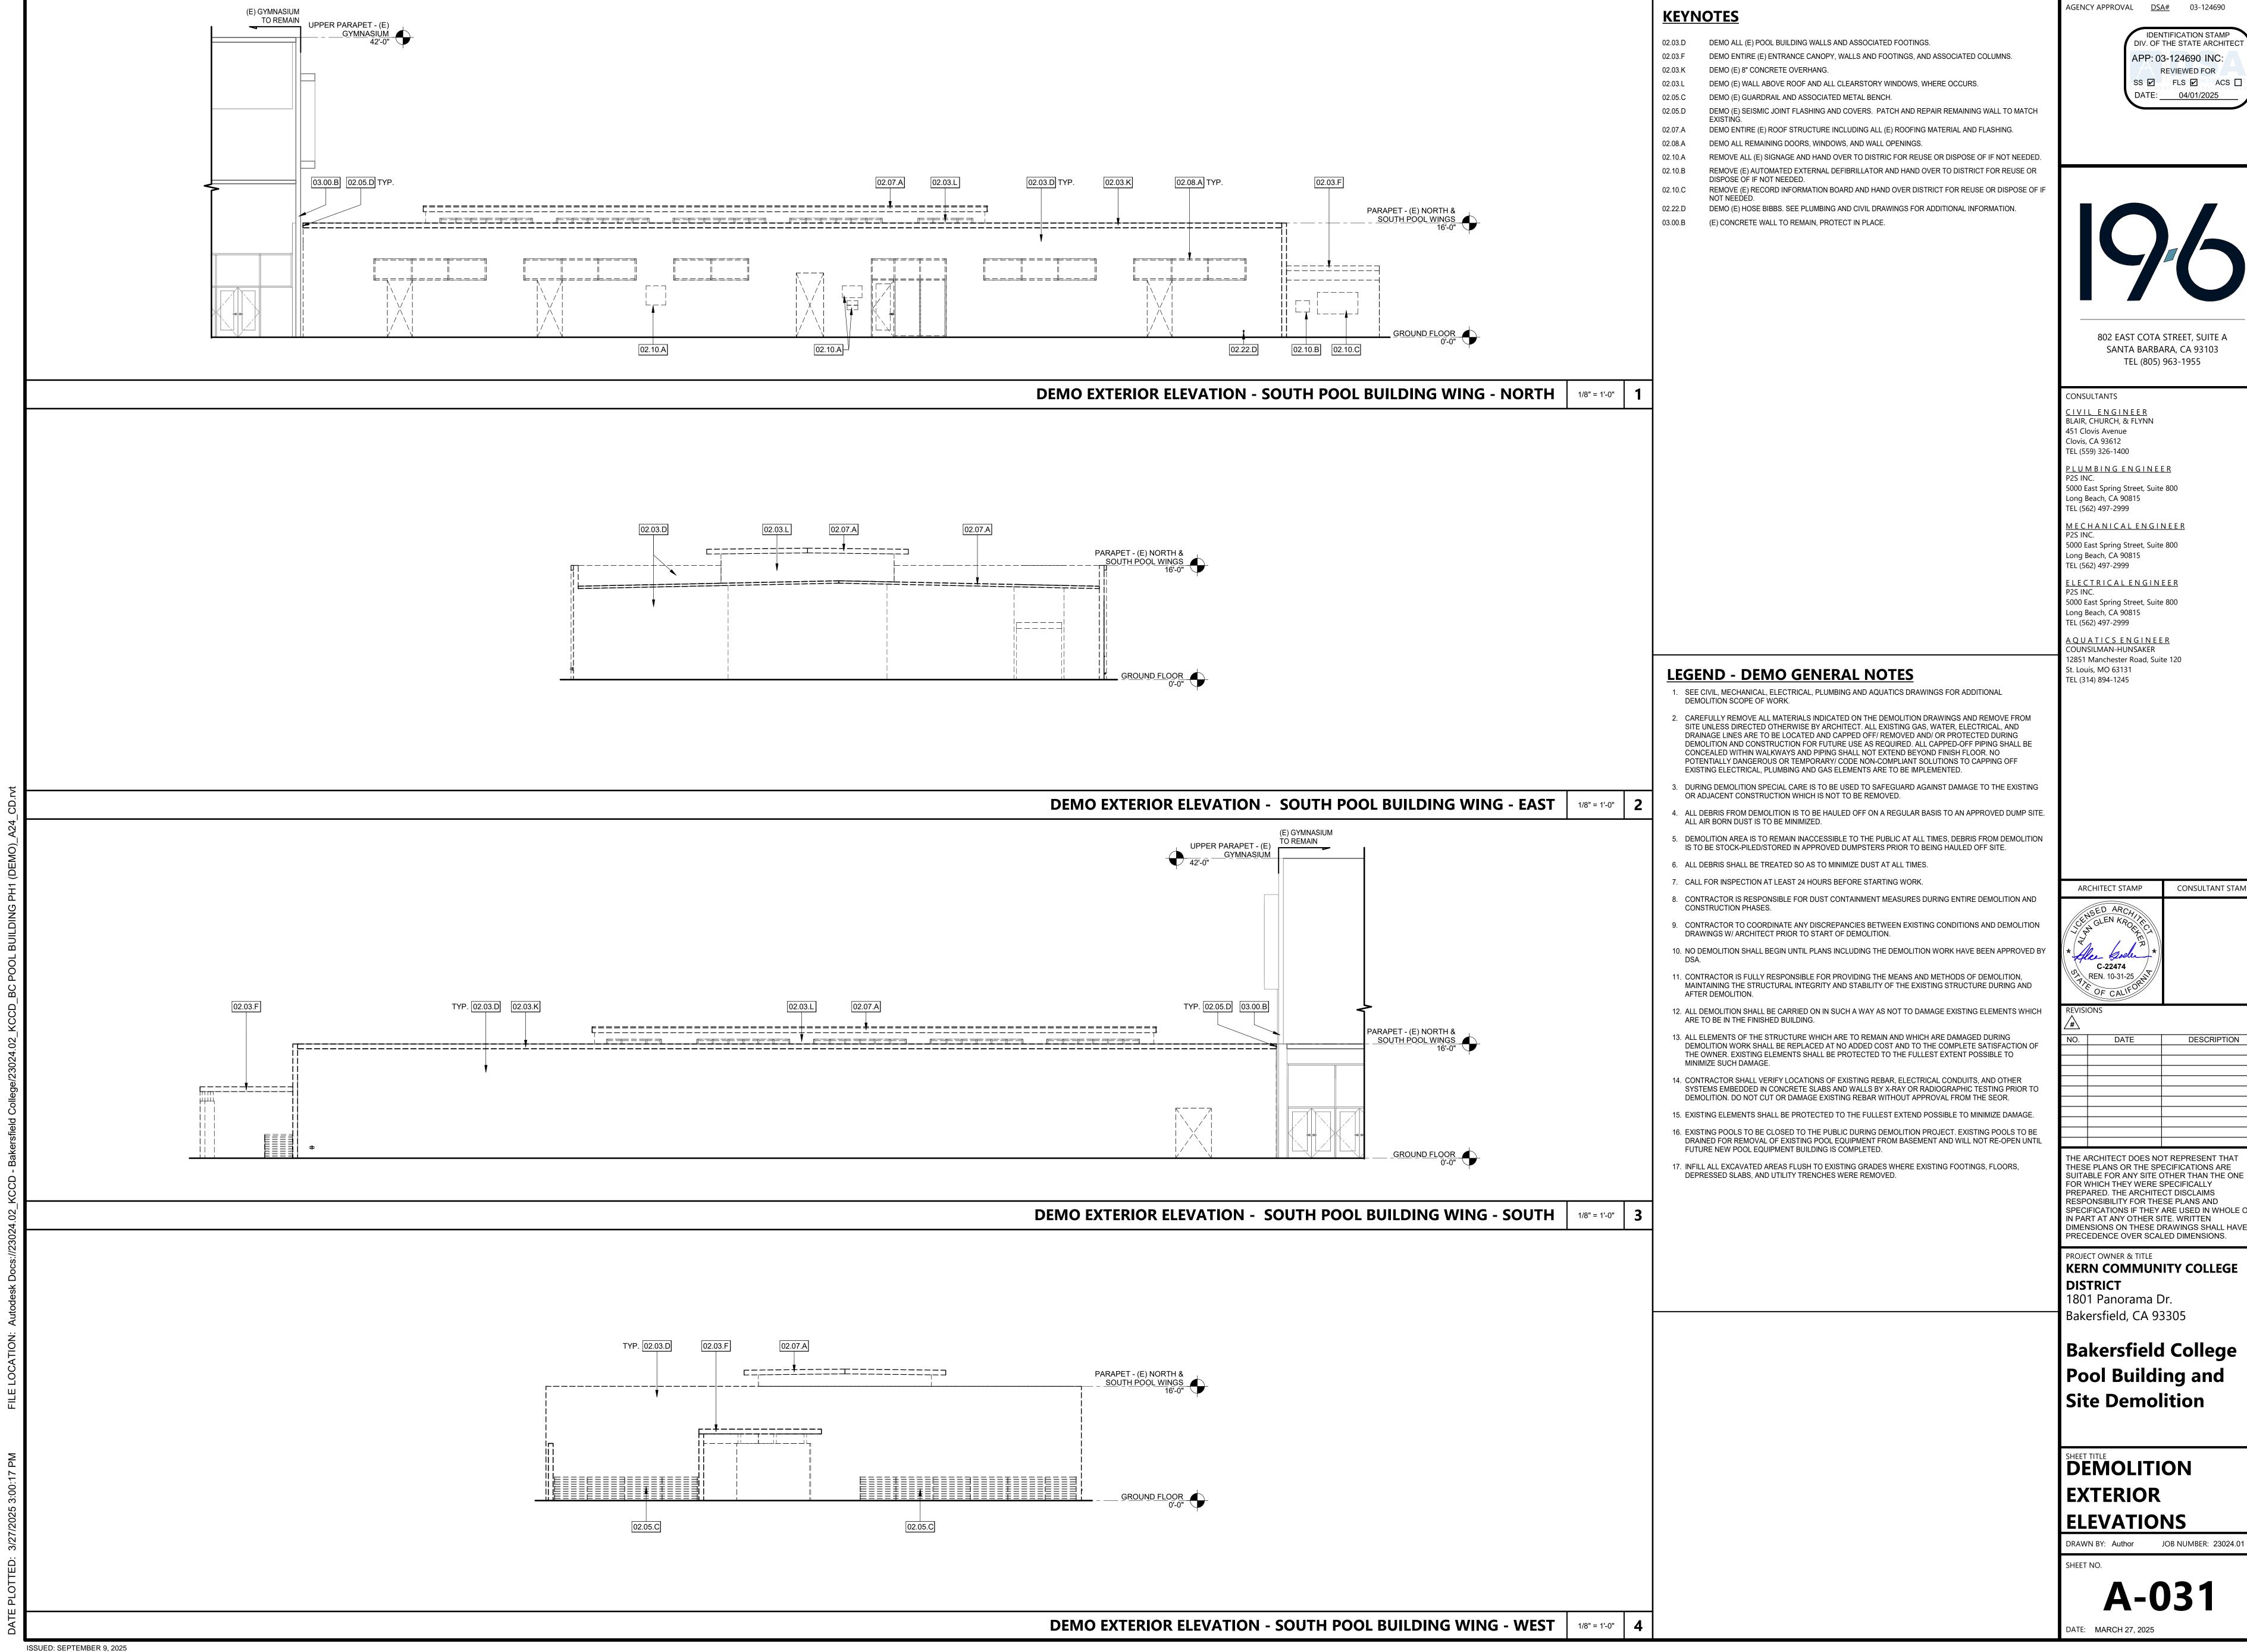


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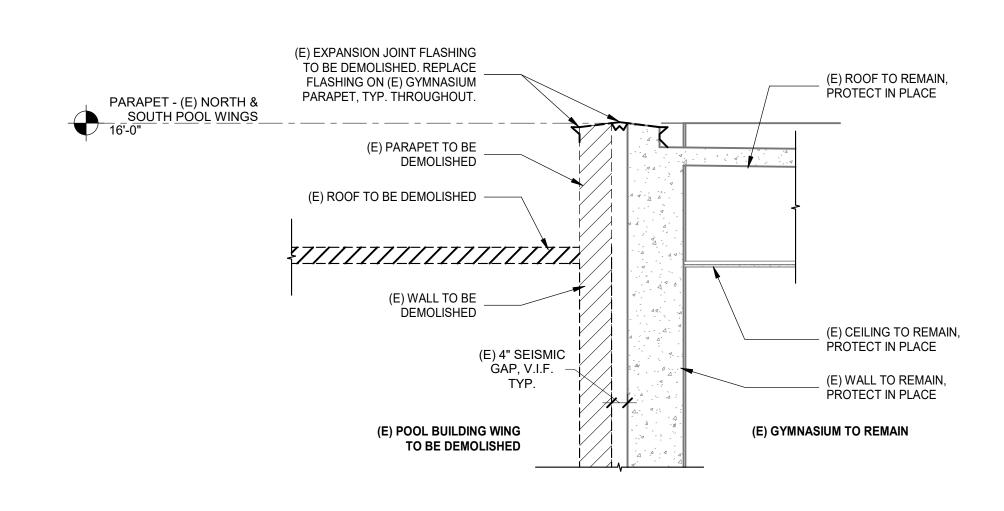



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IDENTIFICATION STAMP DIV. OF THE STATE ARCHITEC APP: 03-124690 INC: REVIEWED FOR SS 🗹 FLS 🗹 ACS 🗆 DATE: <u>04/01/2025</u>

LEGEND - DEMO GENERAL NOTES

1. SEE CIVIL, MECHANICAL, ELECTRICAL, PLUMBING AND AQUATICS DRAWINGS FOR ADDITIONAL DEMOLITION SCOPE OF WORK.

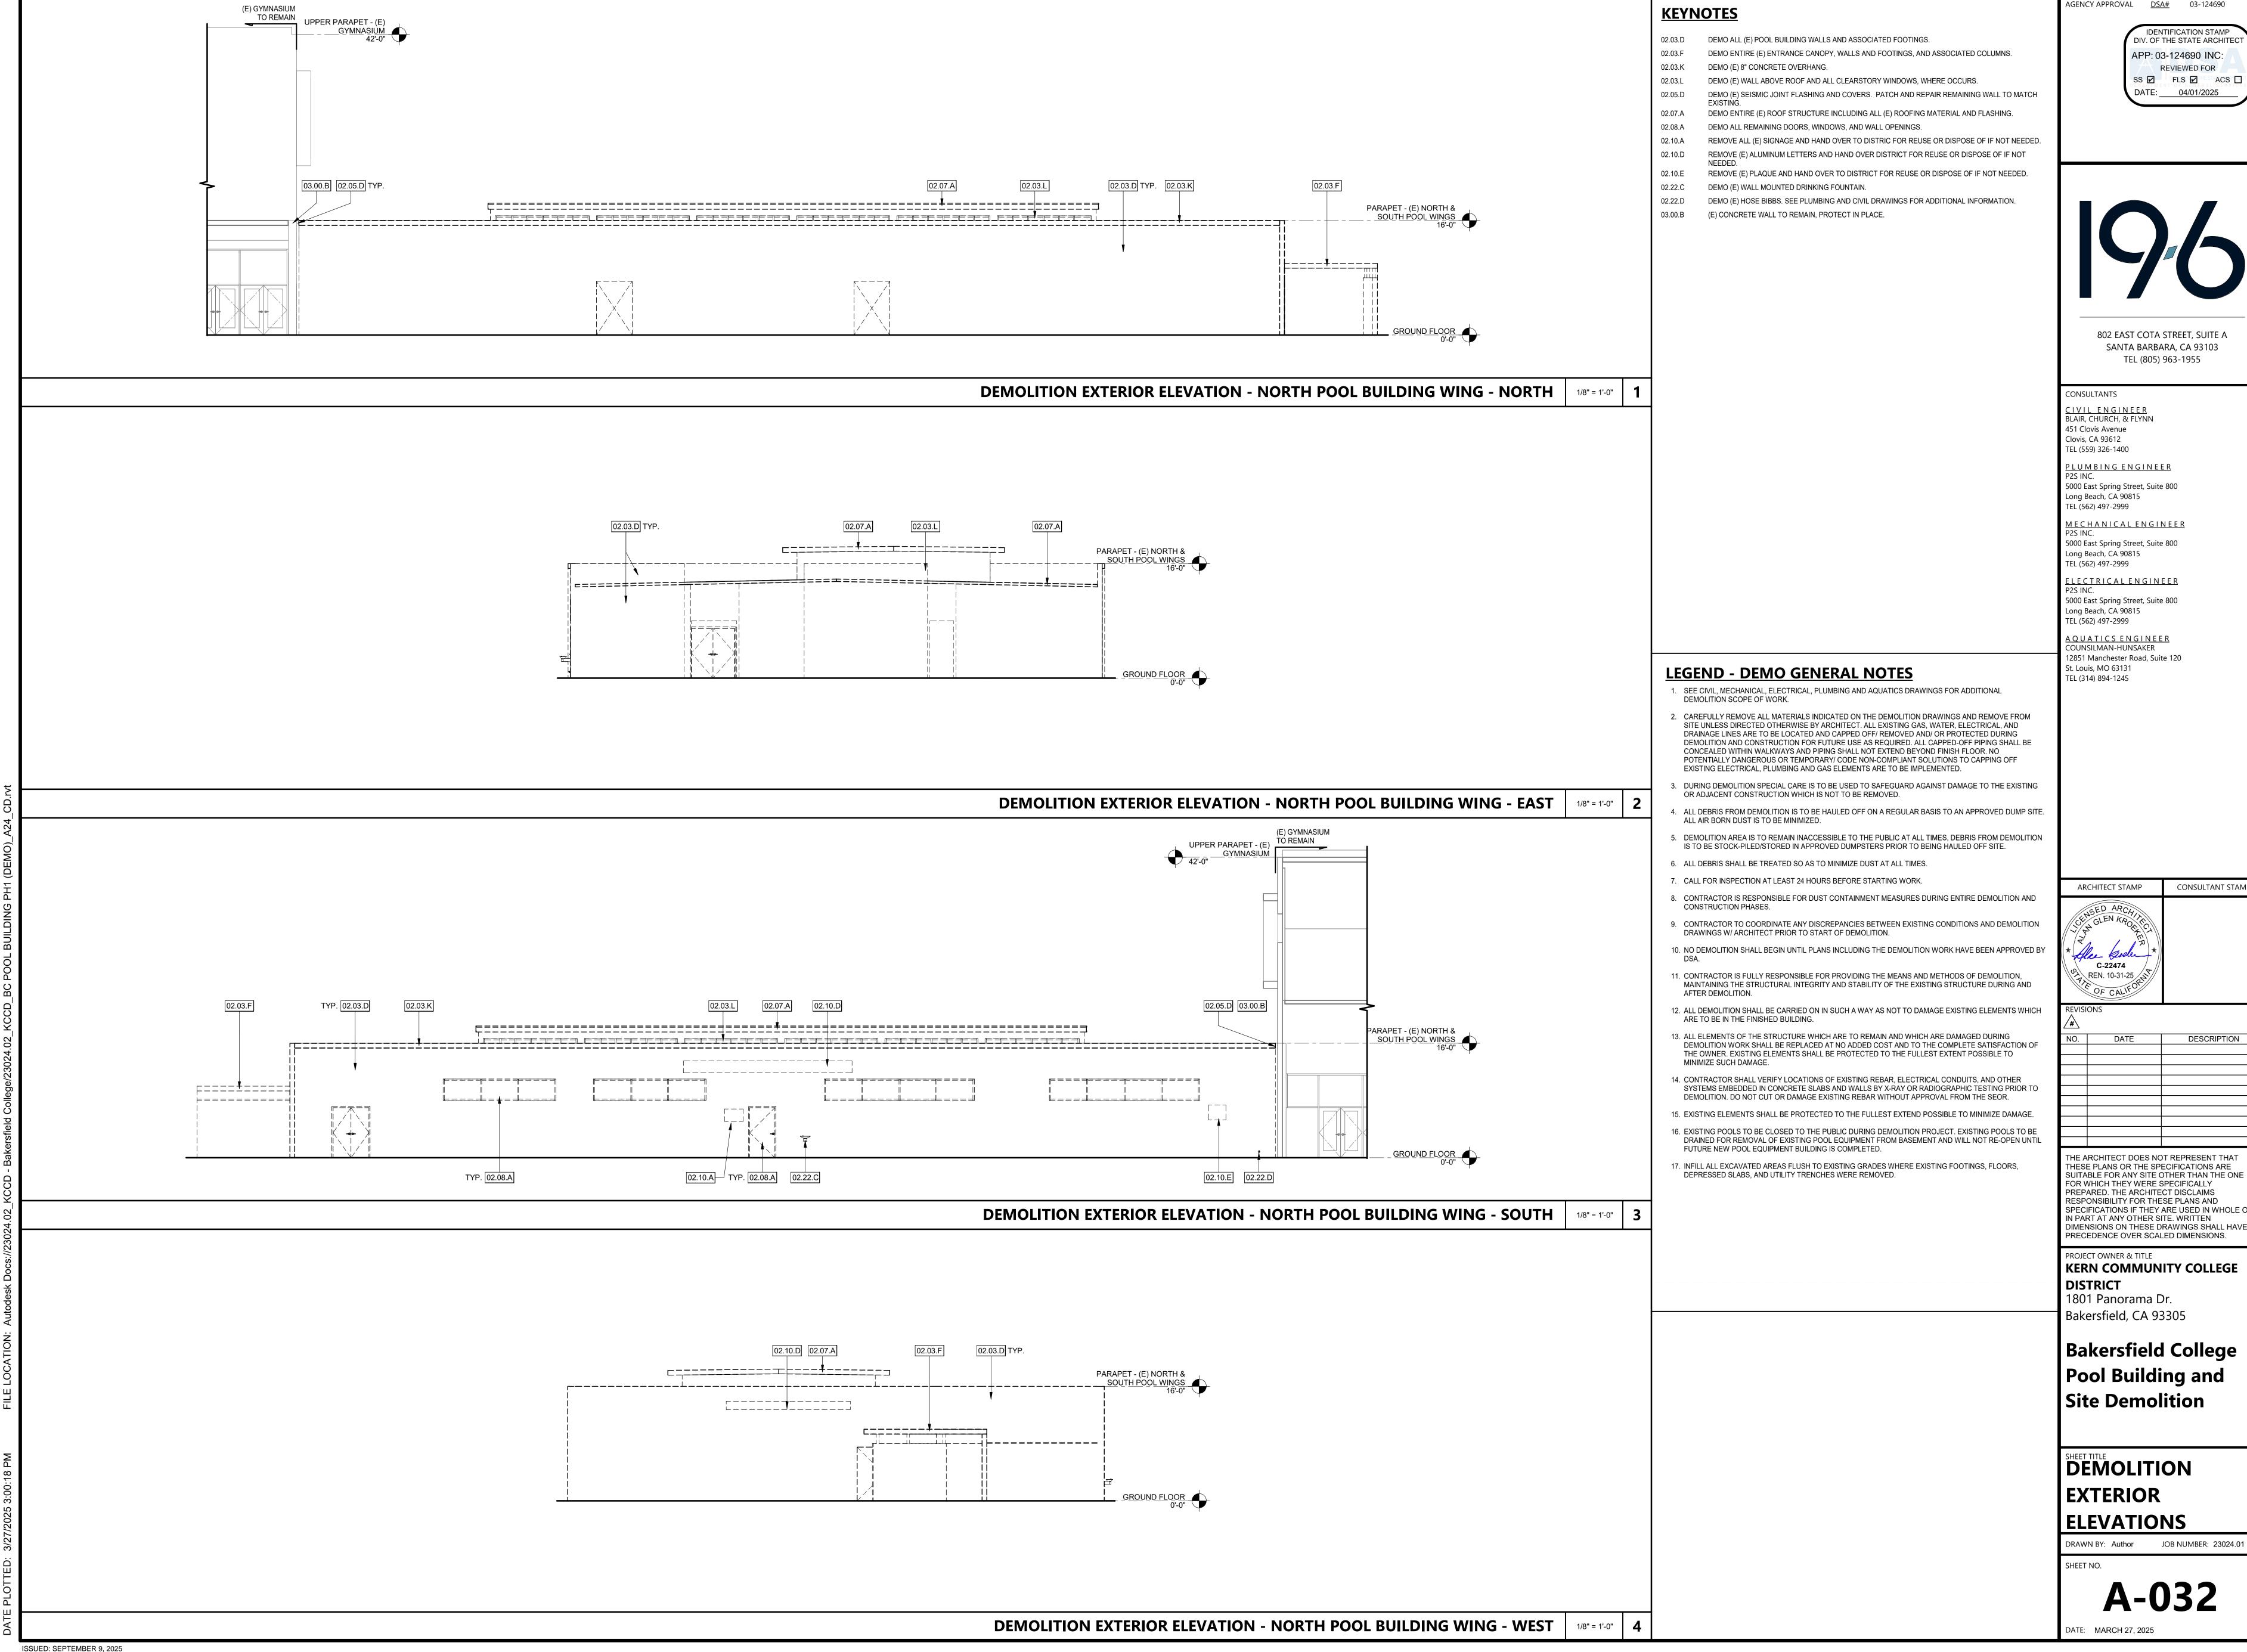SITE UNLESS DIRECTED OTHERWISE BY ARCHITECT. ALL EXISTING GAS, WATER, ELECTRICAL, AND DRAINAGE LINES ARE TO BE LOCATED AND CAPPED OFF/ REMOVED AND/ OR PROTECTED DURING DEMOLITION AND CONSTRUCTION FOR FUTURE USE AS REQUIRED. ALL CAPPED-OFF PIPING SHALL BE CONCEALED WITHIN WALKWAYS AND PIPING SHALL NOT EXTEND BEYOND FINISH FLOOR. NO POTENTIALLY DANGEROUS OR TEMPORARY/ CODE NON-COMPLIANT SOLUTIONS TO CAPPING OFF EXISTING ELECTRICAL, PLUMBING AND GAS ELEMENTS ARE TO BE IMPLEMENTED.

2. CAREFULLY REMOVE ALL MATERIALS INDICATED ON THE DEMOLITION DRAWINGS AND REMOVE FROM

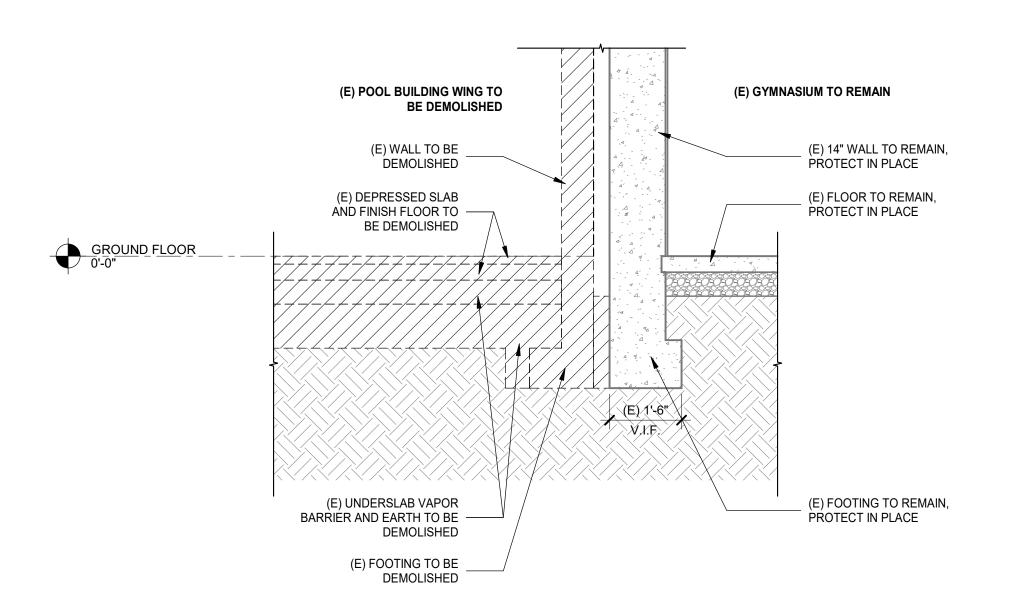- 3. DURING DEMOLITION SPECIAL CARE IS TO BE USED TO SAFEGUARD AGAINST DAMAGE TO THE EXISTING OR ADJACENT CONSTRUCTION WHICH IS NOT TO BE REMOVED.
- 4. ALL DEBRIS FROM DEMOLITION IS TO BE HAULED OFF ON A REGULAR BASIS TO AN APPROVED DUMP SITE. ALL AIR BORN DUST IS TO BE MINIMIZED.
- 5. DEMOLITION AREA IS TO REMAIN INACCESSIBLE TO THE PUBLIC AT ALL TIMES, DEBRIS FROM DEMOLITION IS TO BE STOCK-PILED/STORED IN APPROVED DUMPSTERS PRIOR TO BEING HAULED OFF SITE.
- 6. ALL DEBRIS SHALL BE TREATED SO AS TO MINIMIZE DUST AT ALL TIMES.
- 7. CALL FOR INSPECTION AT LEAST 24 HOURS BEFORE STARTING WORK.
- 8. CONTRACTOR IS RESPONSIBLE FOR DUST CONTAINMENT MEASURES DURING ENTIRE DEMOLITION AND CONSTRUCTION PHASES.
- 9. CONTRACTOR TO COORDINATE ANY DISCREPANCIES BETWEEN EXISTING CONDITIONS AND DEMOLITION DRAWINGS W/ ARCHITECT PRIOR TO START OF DEMOLITION.
- 10. NO DEMOLITION SHALL BEGIN UNTIL PLANS INCLUDING THE DEMOLITION WORK HAVE BEEN APPROVED B
- 11. CONTRACTOR IS FULLY RESPONSIBLE FOR PROVIDING THE MEANS AND METHODS OF DEMOLITION. MAINTAINING THE STRUCTURAL INTEGRITY AND STABILITY OF THE EXISTING STRUCTURE DURING AND
- 12. ALL DEMOLITION SHALL BE CARRIED ON IN SUCH A WAY AS NOT TO DAMAGE EXISTING ELEMENTS WHICH
- ARE TO BE IN THE FINISHED BUILDING. 13. ALL ELEMENTS OF THE STRUCTURE WHICH ARE TO REMAIN AND WHICH ARE DAMAGED DURING DEMOLITION WORK SHALL BE REPLACED AT NO ADDED COST AND TO THE COMPLETE SATISFACTION OF
- THE OWNER. EXISTING ELEMENTS SHALL BE PROTECTED TO THE FULLEST EXTENT POSSIBLE TO MINIMIZE SUCH DAMAGE.
- SYSTEMS EMBEDDED IN CONCRETE SLABS AND WALLS BY X-RAY OR RADIOGRAPHIC TESTING PRIOR TO DEMOLITION. DO NOT CUT OR DAMAGE EXISTING REBAR WITHOUT APPROVAL FROM THE SEOR.

14. CONTRACTOR SHALL VERIFY LOCATIONS OF EXISTING REBAR, ELECTRICAL CONDUITS, AND OTHER

- 15. EXISTING ELEMENTS SHALL BE PROTECTED TO THE FULLEST EXTEND POSSIBLE TO MINIMIZE DAMAGE.
- 16. EXISTING POOLS TO BE CLOSED TO THE PUBLIC DURING DEMOLITION PROJECT. EXISTING POOLS TO BE DRAINED FOR REMOVAL OF EXISTING POOL EQUIPMENT FROM BASEMENT AND WILL NOT RE-OPEN UNTIL FUTURE NEW POOL EQUIPMENT BUILDING IS COMPLETED.

17. INFILL ALL EXCAVATED AREAS FLUSH TO EXISTING GRADES WHERE EXISTING FOOTINGS, FLOORS,

DEPRESSED SLABS, AND UTILITY TRENCHES WERE REMOVED.

802 EAST COTA STREET, SUITE A SANTA BARBARA, CA 93103 TEL (805) 963-1955

CONSULTANTS

<u>CIVIL ENGINEER</u> BLAIR, CHURCH, & FLYNN 451 Clovis Avenue Clovis, CA 93612

TEL (559) 326-1400 PLUMBING ENGINEER 5000 East Spring Street, Suite 800 Long Beach, CA 90815

TEL (562) 497-2999 <u>MECHANICAL ENGINEER</u>

5000 East Spring Street, Suite 800 Long Beach, CA 90815 TEL (562) 497-2999

<u>ELECTRICAL ENGINEER</u> 5000 East Spring Street, Suite 800

Long Beach, CA 90815 TEL (562) 497-2999 <u>AQUATICS ENGINEER</u> COUNSILMAN-HUNSAKER 12851 Manchester Road, Suite 120

St. Louis, MO 63131

TEL (314) 894-1245

CONSULTANT STAMP ARCHITECT STAMP C-22474 REN. 10-31-25

REVISIONS DATE

DESCRIPTION

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PROJECT OWNER & TITLE KERN COMMUNITY COLLEGE DISTRICT

1801 Panorama Dr. Bakersfield, CA 93305

Bakersfield College Pool Building and **Site Demolition**

DEMOLITION SECTIONS

DRAWN BY: Author JOB NUMBER: 23024.01

A-041

ISSUED: SEPTEMBER 9, 2025

SECTION THROUGH (E) GYMNASIUM 1/2" = 1'-0" 1

SECTION THROUGH (E) GYMNASIUM AT ENTRANCE 1/2" = 1'-0" 2

FOR EXACT LOCATION AND REQUIREMENTS

EQUIPMENT CALLOUT, SEE PLUMBING PLANS FOR EXACT LOCATION AND REQUIREMENTS

SECTION CALLOUT

POINT OF CONNECTION POINT OF DISCONNECTION

NEW PIPE (SIZE-SERVICE)

EXISTING PIPE/EQUIPMENT DEMOLISHED PIPE/EQUIPMENT

≻ − − − − → SANITARY VENT

DOMESTIC / INDUSTRIAL HOT WATER RETURN DOMESTIC / INDUSTRIAL HOT WATER SUPPLY DOMESTIC / INDUSTRIAL COLD WATER

ELBOW DOWN

PIPE TEE DOWN

VALVE AT DROP VALVE AT RISE

PIPE TEE UP & DOWN OR ELBOW UP

PIPE TEE UP

CHECK VALVE, SWING

PRESSURE REDUCING VALVE

STRAINER, Y-TYPE

FLOW METER **BACKFLOW PREVENTER**

FLOOR DRAIN FLOOR SINK, 1/2 GRATE

AREA DRAIN / INDUSTRIAL RECEPTOR SHUT-OFF VALVE IN YARDBOX

FLOOR CLEANOUT CLEANOUT TO GRADE WALL CLEANOUT WATER HAMMER ARRESTOR

ABBREVIATIONS

ABBREVIATION DESCRIPTION ABOVE CEILING ABOVE AREA DRAIN AFF ABOVE FINISHED FLOOR AFG ABOVE FINISHED GRADE AUTOMATIC FIRE SPRINKLER RISER **BELOW FLOOR BELOW GRADE** BELOW BACKFLOW PREVENTER BOTTOM BALL VALVE CAST IRON CAST IRON PIPE CEILING COTG CLEAN-OUT TO GRADE DEPARTMENT DRINKING FOUNTAIN DIAMETER DOWN DOWNSPOUT DRAWING(S) DWG EQUIP **EQUIPMENT EWC** ELECTRICAL WATER COOLER EXIST / (E) **EXISTING** FROM ABOVE FROM BELOW FCO FLOOR CLEAN-OUT FLOOR DRAIN FINISHED FLOOR FORCE MAIN FLOOR SINK GALLONS PER MINUTE GAS PRESSURE REGULATOR H&CW HOT AND COLD WATER HIGH LEVEL HDR HEADER INCHES LAVATORY L or LAV MAXIMUM MINIMUM MOUNTED NOT TO SCALE OPEN SCREW AND YOKE POC POINT OF CONNECTION POINT OF DISCONNECTION POD POUNDS PER SQUARE INCH **ROOF DRAIN** RI & C ROUGH-IN AND CONNECT

WALL CLEAN-OUT WATER HEATER WATER HAMMER ARRESTOR

UNLESS OTHERWISE NOTED

SHUT-OFF VALVE

SQUARE

TYPICAL

URINAL

WITH

SERVICE SINK

TRAP PRIMER

UNDERGROUND

VENT THRU ROOF

WATER CLOSET

TO ABOVE TO BELOW

SOV

UON

PIPE SYSTEM ABBREVIATIONS

ABBREVIATION DESCRIPTION ARGON ACID WASTE AWV ACID VENT CO2 CARBON DIOXIDE METHANE COMPRESSED AIR CONDENSATE DRAIN

DOMESTIC COLD WATER DEIONIZED WATER FIRE PROTECTION WATER SUPPLY LOW PRESSURE NATURAL GAS **GREASE WASTE** GREASE WASTE VENT HYDROGEN HELIUM HIGH PRESSURE COMPRESSED AIR HIGH PRESSURE GAS DOMESTIC HOT WATER

DOMESTIC HOT WATER RETURN INDUSTRIAL COLD WATER INDUSTRIAL HOT WATER INDUSTRIAL HOT WATER RETURN INDIRECT WASTE LIQUID NITROGEN MEDIUM PRESSURE GAS NITROGEN OXYGEN **OVERFLOW DRAIN** SANITARY STORM DRAIN SUB SOIL DRAINAGE

TEMPERED WATER TEMPERED WATER RETURN VACUUM WASTE

GENERAL NOTES, LEGEND, ABBREVIATIONS AND SHEET INDEX

SHEET INDEX

ENLARGED SITE PLAN

BASEMENT DEMOLITION PLAN DEMOLITION FLOOR PLANS

DEMOLITION NOTES

- 1. PRIOR TO BID THE CONTRACTOR SHALL VISIT THE JOBSITE TO DETERMINE THE EXTENT OF SCOPE. IF FIELD CONDITIONS DIFFER SIGNIFICANTLY FROM THOSE SHOWN ON THE DRAWINGS AND AFFECTED WORK, INFORM ARCHITECT IMMEDIATELY BEFORE PROCEEDING WITH BID.
- 2. CONTRACTOR SHALL INCLUDE IN HIS BID THE FOLLOWING; RELOCATE, REWORK, REROUTE OF EXISTING PLUMBING SYSTEM PIPING AND PLUMBING TRADE ITEMS BY NEW WALLS, CONSTRUCTION AND CEILINGS AS REQUIRED THROUGHOUT THE JOB TO ACCOMMODATE RENOVATIONS AND/OR
- 3. CONTRACTOR SHALL VERIFY EXISTING SYSTEMS, EXACT LOCATION, SERVICE, INVERT, SIZE, DIRECTION OF FLOW AND AVAILABLE PRESSURE PRIOR TO START ON ANY WORK.
- 4. CONTRACTOR SHALL FIELD VERIFY EXACT LOCATION OF ALL EXISTING UTILITIES TO WHERE HE IS TO CONNECT PRIOR TO INSTALLATION OF ANY PIPING. EXTEND NEW PIPING AS NECESSARY TO WHERE THE EXISTING IS.
- 5. DRAWINGS ARE ESSENTIALLY DIAGRAMMATIC AND ARE NOT INTENDED TO INDICATE NECESSARY OFFSETS OF PIPING, FITTINGS & APPURTENANCES THAT HAVE TO BE REMOVED, CAPPED OR REROUTED.
- 6. LOCATIONS OF EXISTING PIPING IF SHOWN ON THE PLUMBING DRAWINGS ARE APPROXIMATE AND SHOULD BE CONSIDERED DIAGRAMMATIC TO SHOW DESIGN INTENT. EXISTING INFORMATION DERIVED IN-PART BY LIMITED FIELD OBSERVATIONS AND/OR AS-BUILT INFORMATION WHICH MAY BE OUT-DATED AND MAY NOT BE ALL INCLUSIVE OF THE CONDITIONS THAT EXIST.
- 7. UTILITY SHUTDOWNS AND WORK ON EXISTING SYSTEMS AT PORTIONS OF THE BUILDING THAT CAN DISRUPT BUILDING OPERATIONS SHALL BE COORDINATED AND APPROVED BY DISTRICT REPRESENTATIVE PRIOR TO CONNECTING, CUTTING OR CAPPING ANY PIPES.

8. ALL CONNECTIONS TO EXISTING SERVICES SHALL BE MADE SUCH THAT INTERRUPTION TIME WILL

- BE AS SHORT AS POSSIBLE. THE CONTRACTOR SHALL GIVE THE OWNER'S REPRESENTATIVE SUFFICIENT NOTICE OF SUCH INTERRUPTION AND THE ACTUAL SHUT DOWN TIME SHALL BE AT A TIME DESIGNATED BY THE OWNER'S REPRESENTATIVE.
- 9. EXISTING PIPING SYSTEMS NOT BEING RE-USED SHALL BE CUT-BACK TO SOURCE, ABOVE CEILING, BELOW FLOOR OR BEHIND WALLS AS NEEDED AND CAPPED IN AN APPROVED MANNER.
- 10. CONTRACTOR SHALL NOT BORE, NOTCH, CUT OR PENETRATE INTO A STRUCTURE MEMBER WITHOUT PRIOR WRITTEN APPROVAL FROM THE STRUCTURAL ENGINEER OF RECORD, DIVISION OF THE STATE ARCHITECT (DSA) AND THE OWNER UNLESS SPECIFICALLY IDENTIFIED ON THE DSA APPROVED CONSTRUCTION DOCUMENTS.
- 11. WHERE SPACE CONDITIONS ARE TIGHT CONTRACTOR SHALL VERIFY ALL SPACE CONDITIONS, NEW CEILING HEIGHTS AND CONSTRUCTION BY ALL TRADES, ROUTING ELEVATIONS, AND CONDITIONS WITH NEW HVAC DUCTWORK AND RELOCATE OR MODIFY ALL NEW WORK AND RELOCATE EXISTING SYSTEMS WHETHER OR NOT SPECIFICALLY SHOW AS REQUIRED TO ACCOMPLISH INTENT OF WORK SHOWN, SUBJECT TO REVIEW BY ENGINEER.
- 12. ALL EXISTING PIPING DAMAGED DURING CONSTRUCTION SHALL BE REPAIRED WITH MATERIALS TO MATCH EXISTING BY THE CONTRACTOR.
- 13. FIXTURES, PIPES, VALVES, ETC. REMOVED FROM THE BUILDING SHALL BECOME THE PROPERTY OF THE CONTRACTOR AND SHALL BE REMOVED FROM THE SITE.
- 14. EXISTING MATERIALS THAT ARE REMOVED SHALL NOT BE REUSED IN NEW SYSTEMS, EXCEPT WHERE INDICATED AS BEING RELOCATED.
- 15. EXISTING VENTS THRU ROOF (VTR's) IF NOT REUSED, SHALL BE REMOVED AND HOLE SHALL BE PATCHED.
- 16. CONCRETE SLAB AT EXISTING FLOOR DRAIN LOCATIONS TO BE REMOVED SHALL BE REPAIRED AROUND NEW DRAIN BODY FOR A PROPER INSTALLATION.
- 17. CONTRACTOR SHALL BE RESPONSIBLE FOR ALL WORK REQUIRED FOR THE INSTALLATION OF ALL UNDERGROUND PIPING TO BE ADDED AS INDICATED ON PLANS. WORK INCLUDES SAW CUTTING, REPLACEMENT OR BORING UNDER EXISTING HARD SURFACES AND/OR TRENCHING, EXCAVATION AND BACKFILLING AT LANDSCAPE AREAS.
- 18. ALL CUTTING OF EXISTING PAVING, WALKS, AND/OR FLOORS SHALL BE BY MACHINE SAW CUT. HOLES FOR PIPES IN CONCRETE WALLS OR FLOORS SHALL BE DONE BY CORE DRILLING EQUIPMENT.
- 19. CONTRACTOR SHALL BE RESPONSIBLE FOR THE REPLACEMENT OF ALL LANDSCAPE AND/OR HARDSCAPE, AFFECTED BY NEW PLUMBING WORK AND REPAIRED TO MATCH EXISTING OR BETTER. FOR SLAB ON GRADE REPLACEMENT REFER TO STRUCTURAL DRAWINGS.
- 20. CONTRACTOR SHALL BE RESPONSIBLE FOR THE REPLACEMENT OF ALL WALLS AND/OR FLOOR SLABS, AFFECTED BY NEW PLUMBING WORK AND REPAIRED TO MATCH EXISTING OR BETTER.
- 21. ALL PIPING AND DUCTWORK THAT IS EXPOSED IN A NON MECHANICAL ROOM OR OUTSIDE OF THE BUILDING SHALL BE PAINTED PER THE ARCHITECTS DIRECTION. THE CONTRACTOR SHALL SUBMIT PROPOSED PAINTING TO THE ARCHITECT.

GENERAL NOTES

- 1. ALL WORK SHALL COMPLY WITH THE 2022 EDITIONS OF THE CALIFORNIA BUILDING, MECHANICAL, PLUMBING. AND OTHER APPLICABLE FEDERAL. STATE. OR LOCAL CODES AS ADOPTED AND ENFORCED BY THE LOCAL JURISDICTION. IN CASE THE PLANS SHOW MORE STRINGENT REQUIREMENTS, THE PLANS SHALL GOVERN THE DESIGN, YET NOTHING ON THE DESIGN
- 2. SUBMISSION OF BID IN CONNECTION WITH THIS WORK SHALL IMPLY THAT THE BIDDER HAS THIS CONTRACT. NO EXTRA CHARGE WILL BE ALLOWED FOR FAILURE OF ANY BIDDER TO EXAMINE THE SITE PRIOR TO BID.
- 4. IN THE EVENT OF A CONFLICT OR INCONSISTENCY BETWEEN ITEMS INDICATED ON DESIGN PLANS /
- 5. CONTRACTOR SHALL COORDINATE THEIR WORK WITH ALL OTHER TRADES PRIOR TO FABRICATION, PURCHASE AND/OR INSTALLATION OF ALL WORK.
- 6. CONTRACTOR SHALL FURNISH LABOR, MATERIALS, EQUIPMENT, AND TRANSPORTATION AS REQUIRED TO PROPERLY INSTALL ALL PLUMBING SYSTEMS OR RELATED COMPONENTS AS
- 7. CONTRACTOR SHALL DOCUMENT AND RELAY ANY MAJOR DEVIATIONS FROM THE DESIGN VERSION OF AUTOCAD OR REVIT.
- 8. NO PIPING, EQUIPMENT, ETC. SHALL BE REMOVED, DISCONNECTED OR SHUT DOWN WITHOUT PRIOR REVIEW WITH THE FACILITY TO CONFIRM THAT AREAS TO REMAIN IN OPERATION WILL NOT BE AFFECTED. IF ANY AREAS NOT WITHIN THE SCOPE OF WORK ARE AFFECTED BY ANY SHUTDOWN, REMOVAL OR DISCONNECTION, SUFFICIENT ADVANCE NOTICE MUST BE GIVEN TO THE FACILITY INDICATING WHICH AREAS WILL BE AFFECTED, WHEN THE PROPOSED SHUTDOWN WILL OCCUR,
- 9. THE ARRANGEMENT OF EQUIPMENT AND PIPING SHOWN ON THE DRAWINGS IS BASED UPON INFORMATION AVAILABLE TO THE ENGINEER AT THE TIME OF DESIGN AND IS NOT INTENDED TO SHOW EXACT DIMENSIONS PECULIAR TO A SPECIFIC MANUFACTURER. THE DRAWINGS ARE, IN PART, DIAGRAMMATIC AND SOME FEATURES OF THE ILLUSTRATED EQUIPMENT INSTALLATION MAY REQUIRE REVISION TO MEET ACTUAL EQUIPMENT INSTALLATION REQUIREMENTS. STRUCTURAL SUPPORTS, FOUNDATIONS, CONNECTED PIPING, VALVES, PIPE SUPPORTS AND ELECTRICAL CONDUIT SPECIFIED MAY HAVE TO BE ALTERED OR ADDITIONAL ITEMS REQUIRED TO ACCOMMODATE THE EQUIPMENT PROVIDED. NO ADDITIONAL PAYMENT WILL BE MADE FOR SUCH REVISIONS, ALTERATIONS AND / OR ADDITIONS.
- 10. PIPING THROUGH FIRE RATED WALLS SHALL BE PER U.L. FIRE RESISTANCE SYSTEM NO. W1001. SEE ARCHITECTURAL PLANS FOR ALL WALL LOCATIONS.
- 11. ALL VALVES, TRAP PRIMERS, WATER HAMMER ARRESTERS OR OTHER EQUIPMENT SHOWN IN WALLS
- 12. ALL CONNECTIONS TO EXISTING SERVICES SHALL BE MADE SUCH THAT INTERRUPTION TIME WILL BE AS SHORT AS POSSIBLE. THE CONTRACTOR SHALL GIVE THE OWNER'S REPRESENTATIVE SUFFICIENT NOTICE OF SUCH INTERRUPTION AND THE ACTUAL SHUT DOWN TIME SHALL BE AT A TIME DESIGNATED BY THE OWNER'S REPRESENTATIVE.
- 13. ALL VALVES, UNIONS, ETC. TO BE SAME SIZE AS LINE SIZE UNLESS OTHERWISE INDICATED ON DRAWINGS.
- 15. ALL SOIL, WASTE, STORM DRAIN, ACID WASTE, GREASE WASTE AND VENT PIPING SHALL SLOPE AT 2% UNLESS OTHERWISE INDICATED.
- 16. BEFORE FABRICATION OR INSTALLATION, THE CONTRACTOR SHALL VERIFY EXACT LOCATIONS OF ALL EQUIPMENT AND FIXTURES. EXACT ROUGH-IN LOCATIONS AND REQUIREMENTS SHALL BE
- 17. VERIFY WITH ARCHITECTURAL DRAWINGS FOR EXACT LOCATIONS OF ALL FLOOR DRAINS, ROOF,
- 18. PROVIDE AND INSTALL WATER HAMMER ARRESTORS IN THE FOLLOWING LOCATIONS (ONLY
 - A. WATER LINES TO LAVATORY HEADERS, WATER CLOSET AND URINAL HEADERS, SERVICE SINKS, KITCHEN SINKS, WASH FOUNTAINS, DRINKING FOUNTAINS, LABORATORIES WITH MEDICAL TYPE FAUCETS AND ON WASH SINKS HAVING 3 OR MORE STATIONS AND ALL OTHER QUICK CLOSING FIXTURE SUCH AS CLOTHES WASHERS, AS CLOSE TO FIXTURE AS
 - ABOVE, ARE SERVED BY A COMMON HEADER.
 - PLATE LARGE ENOUGH TO PERMIT REMOVAL OF ARRESTOR. ACCESS PLATE SHALL BE A
- 19. CLEANOUTS SHALL BE PROVIDED PER 2022 CPC SECTION 707.0 & 719.0 AND TO THE FOLLOWING LOCATIONS:

 - E. AT EACH BASE OF WASTE STACK
 - F. AT EVERY 100 FT OF STRAIGHT RUN OF HORIZONTAL PIPING
 - G. AT EACH AGGREGATE HORIZONTAL CHANGE IN DIRECTION EXCEEDING ONE HUNDRED THIRTY-FIVE (135) DEGREES.
 - H. AT EACH HORIZONTAL DRAINAGE PIPE UPPER TERMINAL

ABOVE EACH URINAL

- 20. ALL PLUMBING FIXTURES AND FITTINGS SHALL MEET CALGREEN MANDATORY REQUIREMENT OF 20% REDUCED FLOW RATE SPECIFIED IN TABLE 5.303.2.3.
- 21. UNLESS SPECIFIED ON STRUCTURAL DRAWINGS, ANY ALTERATION OR MODIFICATIONS TO STRUCTURAL ELEMENTS BY CUTTING, DRILLING, BORING, BRACING, WELDING ETC. SHALL HAVE WRITTEN APPROVAL BY THE STRUCTURAL ENGINEER PRIOR TO START WORK.

- DOCUMENTS SHALL BE INTERPRETED AS AUTHORITY TO VIOLATE CODE(S) OR REGULATION(S). EXAMINED THE JOB SITE UNDER WHICH THE CONTRACTOR WILL BE OBLIGATED TO OPERATE UNDER
- 3. WHERE USED, THE TERM "PROVIDE" SHALL MEAN "FURNISH AND INSTALL".
- SPECIFICATIONS WITH CODE REQUIREMENTS, THE MORE STRINGENT STANDARD SHALL PREVAIL.
- INDICATED ON PLANS AND SPECIFIED HEREIN.
- DOCUMENTS, AND ATTAIN APPROVAL FROM THE MECHANICAL ENGINEER BEFORE PROCEEDING. AS-BUILT COPIES SHALL BE PROVIDED INDICATING ALL CHANGES / DEVIATIONS MADE DURING CONSTRUCTION. CONTRACTOR SHALL PROVIDE COMPLETED AS-BUILT DRAWINGS IN THE LATEST
- AND FOR HOW LONG A PERIOD OF TIME.
- OR ABOVE NON-ACCESSIBLE CEILINGS SHALL BE INSTALLED BEHIND AN ACCESS PANEL.
- 14. UNIONS SHALL BE PROVIDED AND INSTALLED AFTER EACH SCREW-TYPE VALVE AND PRIOR TO EQUIPMENT CONNECTIONS.
- COORDINATED IN FIELD.
- OVERFLOW DRAINS AND FLOOR SINKS.
- NON-FERROUS ARRESTORS MAY BE INSTALLED IN ANY WATER SYSTEM):
- POSSIBLE.
- B. BETWEEN LAST 2 FIXTURES WHEN 3 OR MORE FIXTURES, OTHER THAN THOSE LISTED IN "A"
- C. WHEN ARRESTOR SHALL BE INSTALLED IN WALL OR FURRING, FURNISH WITH AN ACCESS MINIMUM OF 2 INCHES LARGER IN EACH DIRECTION THAN ARRESTOR AND MINIMUM 12" X 12"
- - D. AT EACH BASE OF ROOF DRAIN DOWNSPOUTS.

 - J. BELOW EACH SINK

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DATE

AGENCY APPROVAL DSA# 03-124690

IDENTIFICATION STAMP DIV. OF THE STATE ARCHITEC

REVIEWED FOR

SS 🗹 FLS 🗹 ACS 🗌

APP: 03-124690 INC:

DATE: 04/01/2025

802 EAST COTA STREET, SUITE A

SANTA BARBARA, CA 93103

TEL (805) 963-1955

CONSULTANTS

451 Clovis Avenue

Clovis, CA 93612

TEL (559) 326-1400

Long Beach, CA 90815

Long Beach, CA 90815

Long Beach, CA 90815

TEL (562) 497-2999

St. Louis, MO 63131

TEL (314) 894-1245

TEL (562) 497-2999

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P2S INC.

P2S INC.

<u>CIVIL ENGINEER</u>

BLAIR, CHURCH, & FLYNN

<u>PLUMBING ENGINEER</u>

5000 East Spring Street, Suite 800

MECHANICAL ENGINEER

5000 East Spring Street, Suite 800

<u>LECTRICAL ENGINEER</u>

5000 East Spring Street, Suite 800

<u>AQUATICS ENGINEER</u>

12851 Manchester Road, Suite 120

COUNSILMAN-HUNSAKER

ARCHITECT STAMP

REVISIONS

CONSULTANT STAMP

DESCRIPTION

PROJECT OWNER & TITLE KERN COMMUNITY COLLEGE DISTRICT 1801 Panorama Dr.

Bakersfield, CA 93305 **Bakersfield College Pool Buildings and Site Demolition**


GENERAL NOTES, LEGEND, ABBREVIATIONS & SHEET INDEX

DRAWN BY: XX JOB NUMBER: 23024.01

DEMOLITION FLOOR PLAN - NORTH POOL BUILDING WING

SCALE: 1/8" = 1'-0"

1 DEMOLITION FLOOR PLAN - SOUTH POOL BUILDING WING

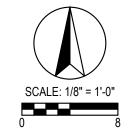

AGENCY APPROVAL DSA# 03-124690

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DIV. OF THE STATE ARCHITECT

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SS FLS ACS
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802 EAST COTA STREET, SUITE A SANTA BARBARA, CA 93103 TEL (805) 963-1955

CONSULTANTS

CIVIL ENGINEER
BLAIR, CHURCH, & FLYNN
451 Clovis Avenue
Clovis, CA 93612
TEL (559) 326-1400

PLUMBING ENGINEER
P2S INC.
5000 East Spring Street, Suite 800
Long Beach, CA 90815
TEL (562) 497-2999

MECHANICAL ENGINEER
P2S INC.
5000 East Spring Street, Suite 800
Long Beach, CA 90815

TEL (562) 497-2999

ELECTRICALENGINEER
P2S INC.
5000 East Spring Street, Suite 800
Long Beach, CA 90815

TEL (562) 497-2999

A Q U A T I C S E N G I N E E R

COUNSILMAN-HUNSAKER

12851 Manchester Road, Suite 120

St. Louis, MO 63131

TEL (314) 894-1245

NOTEC

1 DEMOLISH GAS LINE BACK TO GAS METER.

ARCHITECT STAMP

CONSULTANT STAMP

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REVISIONS

NO. DATE DESCRIPTION

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RERN COMMUNITY
COLLEGE
DISTRICT
1801 Panorama Dr.
Bakersfield, CA 93305

Bakersfield College Pool Buildings and Site Demolition

HEET TITLE

DEMOLITION FLOOR PLANS

DRAWN BY: XX JOB NUMBER: 23024.01

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AGENCY APPROVAL <u>DSA#</u> 03-124690

802 EAST COTA STREET, SUITE A SANTA BARBARA, CA 93103 TEL (805) 963-1955

CONSULTANTS

CIVIL ENGINEER BLAIR, CHURCH, & FLYNN 451 Clovis Avenue Clovis, CA 93612 TEL (559) 326-1400

PLUMBING ENGINEER P2S INC. 5000 East Spring Street, Suite 800 Long Beach, CA 90815 TEL (562) 497-2999

MECHANICAL ENGINEER P2S INC. 5000 East Spring Street, Suite 800 Long Beach, CA 90815 TEL (562) 497-2999

ELECTRICAL ENGINEER P2S INC. 5000 East Spring Street, Suite 800 Long Beach, CA 90815 TEL (562) 497-2999

AQUATICS ENGINEER COUNSILMAN-HUNSAKER 12851 Manchester Road, Suite 120 St. Louis, MO 63131 TEL (314) 894-1245

ARCHITECT STAMP	CONSULTANT STAMP
	No. M41308 No. M41308 No. M41308 SIGNED: 02/28/2025

REVISIONS #

NO.	DATE	DESCRIPTION


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PROJECT OWNER & TITLE

KERN COMMUNITY COLLEGE **DISTRICT** 1801 Panorama Dr.

Bakersfield, CA 93305 **Bakersfield College Pool Buildings and Site Demolition**

ENLARGED SITE PLAN

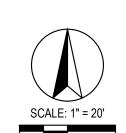

JOB NUMBER: 23024.01

AGENCY APPROVAL <u>DSA#</u> 03-124690

IDENTIFICATION STAMP DIV. OF THE STATE ARCHITECT APP: 03-124690 INC: REVIEWED FOR SS 🗹 FLS 🗹 ACS 🗆 DATE: <u>04/01/2025</u>

802 EAST COTA STREET, SUITE A SANTA BARBARA, CA 93103 TEL (805) 963-1955

CONSULTANTS

CIVIL ENGINEER BLAIR, CHURCH, & FLYNN 451 Clovis Avenue Clovis, CA 93612 TEL (559) 326-1400

PLUMBING ENGINEER P2S INC. 5000 East Spring Street, Suite 800 Long Beach, CA 90815 TEL (562) 497-2999

MECHANICAL ENGINEER
P2S INC. 5000 East Spring Street, Suite 800 Long Beach, CA 90815 TEL (562) 497-2999

ELECTRICAL ENGINEER
P2S INC. 5000 East Spring Street, Suite 800 Long Beach, CA 90815 TEL (562) 497-2999

A Q U A T I C S E N G I N E E R COUNSILMAN-HUNSAKER 12851 Manchester Road, Suite 120 St. Louis, MO 63131 TEL (314) 894-1245

> ARCHITECT STAMP CONSULTANT STAMP

REVISIONS

#		
NO.	DATE	DESCRIPTION

THE ARCHITECT DOES NOT REPRESENT THAT THESE PLANS OR THE SPECIFICATIONS ARE SUITABLE FOR ANY SITE OTHER THAN THE ONE FOR WHICH THEY WERE SPECIFICALLY PREPARED. THE ARCHITECT DISCLAIMS RESPONSIBILITY FOR THESE PLANS AND SPECIFICATIONS IF THEY ARE USED IN WHOLE OR IN PART AT ANY OTHER SITE. WRITTEN DIMENSIONS ON THESE DRAWINGS SHALL HAVE PRECEDENCE OVER SCALED DIMENSIONS.

PROJECT OWNER & TITLE

KERN COMMUNITY COLLEGE **DISTRICT** 1801 Panorama Dr.

Bakersfield, CA 93305

Bakersfield College Pool Buildings and **Site Demolition**

BASEMENT DEMOLITION PLAN

JOB NUMBER: 23024.01

LEGEND DESCRIPTION SYMBOL SYMBOL $^{\mathsf{X}}\mathsf{O}_{\mathsf{y}}$ NOTE CALLOUT DETAIL CALLOUT - NUMBER ON TOP DENOTES DETAIL NUMBER - NUMBER ON BOTTOM DENOTES SHEET DETAIL IS SHOWN MECHANICAL EQUIPMENT CALLOUT, SEE MECHANICAL PLANS FOR EXACT LOCATION AND REQUIREMENTS ^X**⊘**_V SECTION CALLOUT FEEDER CALLOUT EXISTING FEEDER CALLOUT **NEW LINEWORK** EXISTING LINEWORK DEMOLISHED LINEWORK $\Box \Theta \Box$ CONDUIT CONCEALED IN WALL OR ABOVE CEILING CONDUIT EXPOSED CONDUIT CONCEALED UNDERGROUND OR BELOW FLOOR CONDUIT EMERGENCY MULTI-CHANNEL RACEWAY CONDUIT TURNED UP BRANCH CIRCUIT HOMERUN TO PANELBOARD AND CIRCUITS AS 3/4" CONDUIT, TICK MARKS INDICATE QUANTITY OF #12 AWG WIRES PO (UNLESS NOTED OTHERWISE, NO MARKS INDICATES 2#12 & 1#12 GND - SMALL MARK DENOTES HOT WIRE - LARGE MARK DENOTES NEUTRAL WIRE - DIAGONAL DENOTES GROUND WIRE GENERATOR SWITCH CIRCUIT BREAKER 2-WAY SWITCH, TRANSFER SWITCH **FUSE ***** TRANSFORMER GROUND CONNECTION MOTOR - SINGLE PHASE FRACTIONAL OR INTEGRAL HORSEPOWER ELECTRONIC CIRCUIT MONITOR 480V DRAWOUT BREAKER VARIABLE FREQUENCY DRIVE FUSED DISCONNECT SWITCH NON-FUSED DISCONNECT SWITCH COMBINATION STARTER/DISCONNECT SWITCH SWITCH MOTOR RATED SPLICE TERMINATION EXISTING TERMINATION MEDIUM VOLTAGE - AIR CIRCUIT BREAKER DRAWOUT BREAKER MEDIUM VOLTAGE FUSED DISCONNECT SWITCH MEDIUM VOLTAGE MODULAR SPLICE MEDIUM VOLTAGE EXISTING MODULAR SPLICE 2X4 LIGHT FIXTURE - UPPER CASE LETTER INDICATES LIGHT FIXTURE CALLOUT. LOWER CASE LETTER INDICATES LIGHTING CONTROL ZONE. 2X4 EMERGENCY LIGHT FIXTURE FED FROM GENERATOR/ INVERTER/ 2X2 LIGHT FIXTURE - UPPER CASE LETTER INDICATES LIGHT FIXTURE CALLOUT. LOWER CASE LETTER INDICATES LIGHTING CONTROL ZONE. 2X2 EMERGENCY LIGHT FIXTURE FED FROM GENERATOR/ INVERTER/ LINEAR LIGHT FIXTURE, DIMENSIONS PER PLANS - UPPER CASE LETTER INDICATES LIGHT FIXTURE CALLOUT. LOWER CASE LETTER INDICATES → → ► LIGHTING CONTROL ZONE. EMERGENCY LINEAR LIGHT FIXTURE, DIMENSIONS PER PLANS - LIGHT FIXTURE FED FROM GENERATOR/ INVERTER/ BATTERY BACKUP LINEAR PENDANT LIGHT FIXTURE, DIMENSIONS PER PLANS - UPPER • CASE LETTER INDICATES LIGHT FIXTURE CALLOUT. LOWER CASE LETTER INDICATES LIGHTING CONTROL ZONE.

TRACK LIGHTING - UPPER CASE LETTER INDICATES LIGHT FIXTURE CALLOUT. LOWER CASE LETTER INDICATES LIGHTING CONTROL ZONE.

UNDERCABINET / COVE FIXTURE - UPPER CASE LETTER INDICATES LIGHT

FIXTURE CALLOUT. LOWER CASE LETTER INDICATES LIGHTING CONTROL

FIXTURE CALLOUT. LOWER CASE LETTER INDICATES LIGHTING CONTROL

LED STRIP LIGHT FIXTURE - UPPER CASE LETTER INDICATES LIGHT

DESCRIPTION

BATTERY BACKUP

INVERTER/ BATTERY BACKUP

POLE MOUNTED LUMINAIRE, SINGLE HEAD

POLE MOUNTED LUMINAIRE, DOUBLE HEAD

POLE MOUNTED LUMINAIRE, TRIPLE HEAD

POLE MOUNTED LUMINAIRE, QUAD HEAD

SHADED SIDE DENOTES NUMBER OF FACES

PHOTOCELL FOR EXTERIOR APPLICATIONS

DAYLIGHT SENSOR - CEILING MOUNTED

EMERGENCY RELAY UL 924 COMPLIANT

MOTION SENSOR - CEILING MOUNTED

LIGHTING CONTROL NETWORK DEVICE

DIGITAL TIMER SWITCH

MOTION SENSOR SWITCH

LOW VOLTAGE SWITCH

DIMMER MASTER SWITCH

DIGITAL DIMMING SWITCH

MOTION SENSOR - CORNER OR WALL MOUNTED

COMBINATION MOTION AND DAYLIGHT SENSOR

MOTION SENSOR WITH AISLE/CORRIDOR LENS - CEILING MOUNTED

GRAPHICAL TOUCH SCREEN - LIGHTING CONTROL STATION

THERMOSTAT WITH A 3/4" CONDUIT TO ACCESSIBLE CEILING SPACE

SINGLE POLE SWITCH, DEVICE SHALL BE MOUNTED +48" MAX AND +36"

G=GFI, WP=WEATHERPROOF

G=GFI, WP=WEATHERPROOF

C=CEILING

MODULAR FURNITURE - BASE POWER WHIP FEED CONNECTION

MODULAR FURNITURE - FLOOR BOX FEED CONNECTION

MODULAR FURNITURE - POWER POLE FEED CONNECTION

20A, 125V MODULAR FURNITURE RECEPTACLE

(TO BE PROVIDED AS PART OF THE FURNITURE)

20A, 125V MODULAR FURNITURE RECEPTACLE

(TO BE PROVIDED AS PART OF THE FURNITURE)

LIGHTING CONTROL PANEL - SURFACE MOUNTED

(HALF) CONTROLLED RECEPTACLE

PANELBOARD - RECESSED MOUNTED

PANELBOARD - SURFACE MOUNTED

MIN FROM THE CENTER OF DEVICE:

SWITCH 3-WAY (48" AFF MAXIMUM)

TIMER SWITCH (48" AFF MAXIMUM)

DUAL SWITCH (48" AFF MAXIMUM)

MOUNTED +15" AFF, UNLESS OTHERWISE NOTED

MOUNTED +15" AFF, UNLESS OTHERWISE NOTED

20A, 125V CONTROLLED DUPLEX RECEPTACLE

REFER TO DRAWINGS FOR NEMA CONFIGURATION

RECESSED POKE-THROUGH - POWER/TEL/DATA

20A, 125V DUPLEX RECEPTACLE FIRE RATED TYPE

RECESSED FLOOR BOX - POWER/TEL/DATA

PUSHBUTTON SWITCH

20A, 125V DUPLEX RECEPTACLE

20A, 125V QUAD RECEPTACLE

RECEPTACLE ON DEDICATED CIRCUIT

(HALF) CONTROLLED RECEPTACLE

RECESSED POKE-THROUGH

② 20A, 125V QUAD RECEPTACLE FIRE RATED TYPE

RECESSED ON WALL

FLOOR OR CEILING

JUNCTION BOX

SURFACE

DISTRIBUTION PANEL/ BOARD

EXIT LIGHT FIXTURE WITH DIRECTIONAL ARROWS AS INDICATED.

BOLLARD LUMINAIRE

POST TOP LUMINAIRE

IN GRADE LUMINAIRE

PATHWAY LUMINAIRE

LANDSCAPE FIXTURE

JUNCTION BOX

ZONE.

DOWNLIGHT FIXTURE - UPPER CASE LETTER INDICATES LIGHT FIXTURE

CALLOUT. LOWER CASE LETTER INDICATES LIGHTING CONTROL ZONE.

EMERGENCY DOWNLIGHT FIXTURE FED FROM GENERATOR/ INVERTER/

PENDANT LUMINAIRE - UPPER CASE LETTER INDICATES LIGHT FIXTURE

CALLOUT. LOWER CASE LETTER INDICATES LIGHTING CONTROL ZONE.

FIXTURE CALLOUT. LOWER CASE LETTER INDICATES LIGHTING CONTROL

WALL MOUNTED LIGHT FIXTURE - UPPER CASE LETTER INDICATES LIGHT

FIXTURE CALLOUT. LOWER CASE LETTER INDICATES LIGHTING CONTROL

EMERGENCY WALL MOUNTED LIGHT FIXTURE FED FROM GENERATOR/

WALLWASH LIGHT FIXTURE - UPPER CASE LETTER INDICATES LIGHT

<u>ABBREVIATION</u>	DESCRIPTION	<u>ABBREVIATION</u>	DESCRIPTION
1/C	SINGLE CONDUCTOR	KW	KILOWATT
& @	AND AT	LF LFMC	LINEAR FEET LIQUIDTIGHT FLEXIBLE METAL CONDUIT
A OR AMP	AMPERES	LGST	LARGEST
ABV	ASPUALT CONCRETE	LIS LOC.	LOAD INTERRUPTER SWITCH LOCATION
4.C. 4F	ASPHALT CONCRETE AMPERE FUSE RATING	LOC. LOTO	LOCK-OUT & TAG-OUT
AFC	AVAILABLE FAULT CURRENT	LSI	LONG TERM, SHORT TERM, INSTANTANEOU
AFF AFG	ABOVE FINISHED FLOOR ABOVE FINISHED GRADE	LSIG	LONG TERM, SHORT TERM, INSTANTANEOU GROUNDING
AIC	AMPERE INTERRUPTING CAPACITY	LTG	LIGHTING
AL APPROX.	ALUMINUM APPROXIMATE	LV M	LOW VOLTAGE METER
ARCH.	ARCHITECT; ARCHITECTURAL	MAX	MAXIMUM
AS ASSOCI	AMPERE SWITCH RATING	MCA	MAXIMUM CIRCUIT AMPACITY
ASCC ATC	AVAILABLE SHORT CIRCUIT CURRENT AIR TERMINAL CHAMBER	MCC MCP	MOTOR CONTROL CENTER MOTOR CIRCUIT PROTECTOR
ATO	AUTOMATIC THROW-OVER (SWITCH)	MFGR, MFR	MANUFACTURER
ATS AUTO	AUTOMATIC TRANSFER SWITCH AUTOMATIC	MH MI.	MANHOLE MECHANICAL INTERLOCK
AUX	AUXILIARY	MRCT	MULTI-RATIO CURRENT TRANSFORMER
AWG BAT	AMERICAN WIRE GAUGE BATTERY	MIN MOCP	MINIMUM MAXIMUM OVERCURRENT PROTECTION
BEL	BELOW	MTD	MOUNTED
BKBD	BACKBOARD	MTG	MOUNTING
3KR 3LDG	BREAKER BUILDING	MTR MTTB	MOTOR MAIN TELEPHONE TERMINAL BOARD
3.S.	BARE STRANDED	MV	MEDIUM VOLTAGE
) DD	CONDUIT	N	NORTH NOTIFICATION APPLIANCE CIRCUIT
CB CC	CIRCUIT BREAKER CONSTANT CURRENT	NAC NC	NORMALLY CLOSED
CEC	CALIFORNIA ELECTRICAL CODE	NEC	NATIONAL ELECTRICAL CODE
OF OKT	CUBIC FEET CIRCUIT	NF NIC	NON-FUSED NOT IN CONTRACT
CL	CENTER LINE	NL	NIGHT LIGHT- 24HRS ON
CLG	CEILING CONCRETE MASONRY UNIT	NO. OC	NUMBER ON CENTER
CMU C.O.	CONDUIT ONLY WITH PULL WIRE	OCPD	OVERCURRENT PROTECTIVE DEVICE
COL	COLUMN	OD	OUTSIDE DIAMETER
CP CPT	COMMUNICATION PROCESSOR CONTROL POWER TRANSFORMER	OE OFC	OVERHEAD ELECTRICAL OIL FUSED CUTOUT
CR	CONTROL RELAY	OH	OVERHEAD
CSFD	COMBINATION SMOKE FIRE DAMPER	OL P	OIL LEVER SWITCH
CT CW	CURRENT TRANSFORMER COLD WATER	PAC	POLE PROGRAMMABLE AUTOMATION CONTROLI
CU	COPPER	PB	PULL BOX
DIAG DIST.	DIAGRAM DISTANCE	PC PCB	PHOTOCELL POLYCHLORINATED BIPHENYL
DL	DAMP LOCATION LISTING	PDS	PRESSURE DIFFERENTIAL SWITCH
DM DMM	DIGITAL METER MODULE	PF BU OD Ø	POWER FACTOR
OMM OP	DIGITAL METER MODULE DISTRIBUTION PANEL	PH OR Ø PILC	PHASE PAPER INSULATED, LEAD COVER
DIST.	DISTANCE	PIV	POST INDICATING VALVE
DWG DWP	DRAWING DEPARTMENT OF WATER & POWER	PL PLC	PLATE PROGRAMMABLE LOGIC CONTROLLER
EA	EACH	PNL	PANEL
ECM	ELECTRONIC CIRCUIT MONITOR	POC	POINT OF CONNECTION
ELEC. EM	ELECTRICAL EMERGENCY	PREF. PRI.	PREFERRED PRIMARY
EMH	ELECTRICAL MANHOLE	PVC	POLY-VINYL CHLORIDE
EMT EPO	ELECTRICAL METALLIC TUBING EMERGENCY POWER OFF	PWR REC/RECEPT	POWER RECEPTACLE
EPR	ETHYLENE PROPYLENE RUBBER	REQ'D	REQUIRED
EQUIP	EQUIPMENT	RGS	RIGID GALVANIZED STEEL
ER ERR	EXISTING TO BE REMOVED EXISTING TO BE RELOCATED AND -	RMC RPBP	RIGID METAL CONDUIT REDUCED PRESSURE BACK FLOW PREVEN
	RECONNECTED	RM	ROOM
EXIST/(E) EXP	EXISTING EXPLOSION PROOF	RTAC SCCR	REAL TIME AUTOMATION CONTROLLER SHORT CIRCUIT CURRENT RATING
-A	FIRE ALARM	SCE	SOUTHERN CALIFORNIA EDISON
FFE	FINISHED FLOOR ELEVATION	SF	SQUARE FEET
FIN. FIP.	FINISH FIELD INTERFACE PANEL	SHT SIG.	SHEET SIGNAL
FIXT	FIXTURE	SP	SPARE
FLA FLR	FULL LOAD AMPS FLOOR	SPECS ST	SPECIFICATIONS STREET
FLUOR	FLUORESCENT	STD	STANDARD
FT CD	FEET	STP	SHIELDED TWISTED PAIR
FACP FATC	FIRE ALARM CONTROL PANEL FIRE ALARM TERMINAL CABINET	SW SWBD	SWITCH SWITCHBOARD
MC	FLEXIBLE METAL CONDUIT	SWGR	SWITCHGEAR
FO FTG	FIBER OBTIC FOOTING	SWST TB	SWITCHING STATION TERMINAL BLOCK
GEN	GENERATOR	TEL./TELE	TELEPHONE
GFI GED	GROUND FAULT DELAY	TMH	TELEPHONE MANHOLE
GFR GG	GROUND FAULT RELAY GREEN GROUND	T.O.D. T.O.M.	TOP OF DUCTBANK TOP OF MANHOLE
GND	GROUND	TPS	TWISTED SHIELDED PAIR
HOA HP	HAND-OFF-AUTOMATIC HORSEPOWER	TRANSF,XFMR TS	TRANSFORMER TAMPER SWITCH
⊣T	HEIGHT	TYP	TYPICAL
HTR	HEATER	UG	UNDERGROUND
HZ CON	HERTZ INTEGRATED COMMUNICATIONS OPTICAL -	UON V	UNLESS OTHERWISE NOTED VOLTS
	NETWORK	VA	VOLT-AMPERES
E	INVERT ELEVATION	VB VED	VIBRATION SWITCH
ED MC	INTELLIGENT ELECTRONIC DEVICES INTERMEDIATE METAL CONDUIT	VFD W	VARIABLE FREQUENCY DRIVE WATTS
SC	SHORT CIRCUIT CURRENT	W/	WITH
NCAND J, JB, J-BOX	INCANDESCENT JUNCTION BOX	W/O WCR	WITHOUT WITHSTAND CLOSE-ON RATING
KCMIL	THOUSAND CIRCULAR MILS	WP	WEATHERPROOF
KV	KILOVOLT	Z	IMPEDANCE

IN THE EVENT ABBREVIATIONS NOT MENTIONED HEREIN ARE USED, REFERENCE WILL BE MADE TO ANSI Y1.1, MILITARY STANDARD ABBREVIATIONS, AND OTHER STANDARD INDUSTRY CONVENTIONS.

KILOVOLT-AMPERES

DEMOLITION NOTES

- 1. WORK INCLUDED: ALL LABOR, MATERIAL, APPLIANCES, TOOLS, EQUIPMENT, FACILITIES, TRANSPORTATION AND SERVICES NECESSARY AND INCIDENTAL TO PERFORMING ALL OPERATIONS IN CONNECTION WITH THE DEMOLITION, DISPOSAL, TRANSPORTATION AND RECONNECTION OF EXISTING REMAINING EQUIPMENT/DEVICES. COMPLETE AS INDICATED IN THE CONTRACT DOCUMENTS AS SPECIFIED HEREIN.
- 2. THE FOLLOWING IS INTENDED TO COVER THE COMPLETE DEMOLITION, DISPOSAL, TRANSPORTATION AND RECONNECTION OF EXISTING ELECTRICAL EQUIPMENT. THE OMISSION OF EXPRESSED REFERENCE TO ANY ITEM OF LABOR OR MATERIAL FOR THE PROPER EXECUTION OF THE WORK IN ACCORDANCE WITH PRESENT PRACTICE OF THE TRADE SHALL NOT RELIEVE THE CONTRACTOR FROM PROVIDING SUCH ADDITIONAL LABOR AND MATERIALS.
- 3. REFER TO THE CONTRACT DOCUMENTS FOR ADDITIONAL DEMOLITION REQUIREMENTS WHICH AFFECT THE PROPER EXECUTION OF THIS WORK. DIAGRAMS AND SYMBOLS SHOWING ELECTRICAL CONNECTIONS ARE DIAGRAMMATIC ONLY. WIRING DIAGRAMS DO NOT NECESSARILY SHOW THE EXACT PHYSICAL ARRANGEMENT OF THE EQUIPMENT.
- 4. IT IS THE CONTRACTOR'S RESPONSIBILITY TO VISIT THE SITE AND BECOME THOROUGHLY FAMILIAR WITH ALL FEATURES OF THE BUILDING AND SITE WHICH MAY AFFECT THE PROPER PERFORMANCE OF
- 5. PORTIONS OF THESE PLANS HAVE BEEN DERIVED FROM INFORMATION TAKEN FROM ORIGINAL ELECTRICAL PLANS. THE INTENT OF THE DRAWINGS AND SPECIFICATIONS IS TO PROVIDE FOR THE REMOVAL AND DISPOSAL OF ALL ELECTRICAL EQUIPMENT, LIGHTING FIXTURES, DEVICES, OUTLET BOXES, CONDUIT, WIRING, ETC. AS DEFINED HEREIN AND AS INDICATED ELSEWHERE IN THE CONTRACT DOCUMENTS.
- 6. IT IS UNDERSTOOD AND AGREED THAT THIS CONTRACT DOES NOT CONTEMPLATE THE HANDLING OF ASBESTOS, PCB OR ANY HAZARDOUS WASTE MATERIAL. IF ASBESTOS, PCB OR ANY HAZARDOUS WASTE MATERIAL IS ENCOUNTERED, NOTIFY THE ELECTRICAL ENGINEER IMMEDIATELY. DO NOT DISTURB, HANDLE OR ATTEMPT TO REMOVE.
- 7. THE SCOPE OF DEMOLITION WORK SHALL INCLUDE, BUT IS NOT LIMITED TO THE FOLLOWING:
- A. SUBMIT PROPOSED OUTAGE SCHEDULE. PROVIDE A SEQUENCE OF DEMOLITION TO INSURE THE UNINTERRUPTED USE OF OCCUPIED PORTIONS OF THE FACILITY WHICH ARE TO REMAIN OPERATIONAL DURING THE CONTRACT PERIOD.
- B. SYSTEM OUTAGES SHALL BE PERMITTED ONLY AT TIMES APPROVED BY OWNER, IN WRITING. WORK WHICH COULD RESULT IN A ACCIDENTAL OUTAGE (BEYOND BRANCH CIRCUITS) SHALL BE PERFORMED WITH THE OWNER'S MAINTENANCE PERSONNEL ADVISED OF SUCH WORK.
 - 1) COORDINATE WITH THE OWNER AND DESIGNATE A PORTION OF THE FACILITY FOR SAFELY STORING ALL REMOVED AND SALVAGED MATERIALS.
- C. ALL REMOVED MATERIALS AND EQUIPMENT WHICH IN THE OPINION OF THE OWNER/ARCHITECT ARE SALVAGEABLE, SHALL REMAIN THE PROPERTY OF THE OWNER. DELIVER SUCH SALVAGED MATERIALS AND EQUIPMENT ON PREMISES AS DIRECTED, NEATLY PILE OR STORE THEM AND PROTECT FROM DAMAGE. DO NOT REUSE MATERIALS AND EQUIPMENT UNLESS SPECIFICALLY INDICATED ON PLANS OR SPECIFIED. REMOVE FROM PREMISES AND DISPOSE OF ALL MATERIALS CONSIDERED BY THE OWNER/ARCHITECT TO BE
- D. PERFORM CUTTING AND PATCHING OF THE CONSTRUCTION WORK WHICH MAY BE REQUIRED FOR THE PROPER DEMOLITION OF THE ELECTRICAL WORK. PATCHING SHALL BE OF THE SAME MATERIAL, THICKNESS, WORKMANSHIP AND FINISH AS EXISTING AND ACCURATELY MATCH SURROUNDING WORK TO THE SATISFACTION OF THE OWNER. CUTTING OF STRUCTURAL MEMBERS SHALL NOT BE DONE WITHOUT FIRST OBTAINING APPROVAL FROM THE OWNER AND/OR STRUCTURAL ENGINEER OF RECORD.
 - 1) PATCHING OF OPENINGS IN RATED PARTITIONS, BARRIERS, FLOORS, CEILINGS, ETC. SHALL BE EXECUTED USING UL AND NEPA FIRE STOP MATERIAL EQUAL TO THE FIRE RATINGS OF THE PENETRATED SURFACE.
 - 2) WHERE MATERIALS AND EQUIPMENT HAVE BEEN REMOVED AND NOT REPLACED THE EXPOSED SURFACE SHALL BE PAINTED TO MATCH SURROUNDING SURFACE COLOR.
- E. AS INDICATED, DISCONNECT AND REMOVE EXISTING ELECTRICAL EQUIPMENT, DISCONNECT SWITCHES, RECEPTACLES, MOUNTING HARDWARE AND ASSOCIATED RACEWAYS, CONDUCTORS AND OUTLET BOXES. WHERE OUTLET BOXES ARE FLUSH AND CONDUITS ARE CONCEALED IN EXISTING REMAINING WALLS, REMOVE WIRING AND ABANDON CONDUIT IN
- F. EXCEPT AS NOTED OTHERWISE DISCONNECT AND REMOVE EXISTING FIRE ALARM SYSTEM EQUIPMENT, DEVICES, MOUNTING HARDWARE AND ASSOCIATED RACEWAYS, CONDUCTORS AND OUTLET BOXES. WHERE OUTLET BOXES ARE FLUSH AND CONDUITS ARE CONCEALED IN EXISTING REMAINING WALLS, REMOVE WIRING AND ABANDON CONDUITS IN PLACE.
- G. WHERE INDICATED BY THE DRAWINGS REMOVE EXISTING ELECTRICAL DISTRIBUTION EQUIPMENT INCLUDING SWITCHBOARDS, DISTRIBUTION BOARDS, PANELBOARDS, MOTOR CONTROL CENTERS, TRANSFORMERS, LOAD CENTERS, ETC. MODIFICATIONS TO THE MAIN SWITCHBOARD SHALL NOT TAKE PLACE UNTIL THE SERVING UTILITY POWER COMPANY IS NOTIFIED. COMPLY WITH ALL POWER OUTAGE RESTRICTIONS INDICATED ELSEWHERE IN THE CONTRACT DOCUMENTS.
- H. EXCEPT AS NOTED OTHERWISE REMOVE EXISTING TIMESWITCHES CONTACTORS, RELAYS AND ASSOCIATED CONDUITS AND CONDUCTORS CONTROLLING HVAC SYSTEMS.
- I. WHERE EXISTING WALL AND CEILINGS ARE TO REMAIN, PROVIDE BLANK COVER PLATES FOR OUTLETS WHERE EQUIPMENT OR DEVICES ARE REMOVED UNDER THIS CONTRACT. PRIME BLANK PLATES AND PAINT TO MATCH SURROUNDING AREA.
- J. REFER TO THE DRAWINGS FOR ALL EQUIPMENT TO BE RELOCATED AND REUSED.
- K. THE CONTRACTOR SHALL FIELD VERIFY EXISTING EQUIPMENT, DEVICES, AND/OR CIRCUITS THAT ARE REMAINING. CIRCUITS SHALL BE RECONNECTED TO NEW OR EXISTING POWER DISTRIBUTION EQUIPMENT AND FUNCTION IN THE MANNER THEY WERE ORIGINALLY DESIGNED. PROVIDE ADDITIONAL EQUIPMENT, DEVICES, OUTLET BOXES, CONDUIT, WIRING, ETC. AS REQUIRED TO RESTORE CONTINUITY TO THESE CIRCUITS.
- WHERE FIXTURES, EQUIPMENT, DEVICES, ETC. ARE SPECIFIED BY THE CONTRACT DOCUMENTS FOR REMOVAL, THE CONTRACTOR SHALL REMOVE ALL CIRCUIT CONDUCTORS/CABLING BACK TO THE NEAREST REMAINING JUNCTION BOX AND/OR POINT OF TERMINATION.
- M. PROVIDE ADDITIONAL CONDUIT, CONDUCTORS, CABLING, OUTLET BOXES, ETC. AS REQUIRED FOR THE RELOCATION OF ELECTRICAL APPARATUS.
- N. RELOCATION AND/OR REMOVAL OF EXISTING EQUIPMENT, DEVICES, OUTLET BOXES, CONDUIT. WIRING, ETC. MAY AFFECT THE OPERATION OF EXISTING, REMAINING ELECTRICAL EQUIPMENT /DEVICES. THE CONTRACTOR SHALL PROVIDE ADDITIONAL MATERIALS AS REQUIRED TO MAINTAIN AND/OR RESTORE CONTINUITY OF SERVICE TO EXISTING, REMAINING ELECTRICAL/DEVICES.
- O. PROVIDE ALL NECESSARY DEMOLITION TO REMOVE EXISTING UNUSED RACEWAYS, CONDUCTORS, CABLING, OUTLET BOXES, RECEPTACLES, SWITCHES, EQUIPMENT, ETC.
- P. WHERE IT IS NOT FEASIBLE TO REMOVE UNUSED FLUSH MOUNTED OUTLET BOXES AND CONCEALED RACEWAYS IN EXISTING, REMAINING WALLS AND/OR CEILINGS REMOVE ALL WIRING AND PROVIDE BLANK COVER PLATES OVER OUTLET BOXES.
- Q. ALL CONDUITS RISING FROM BELOW GRADE TO AREAS WHERE PARTITIONS, WALLS, AND/OR OTHER CONSTRUCTION ENTITIES ARE INDICATED AS BEING REMOVED SHALL BE CUT TO BELOW FINISH FLOOR, CAPPED AND ABANDONED. PROVIDE PATCHING AS REQUIRED. SEAL IN A MANNER ACCEPTABLE TO THE OWNER.
- R. COVER UNUSED AND/OR ABANDONED OUTLETS WITH BLANK COVER PLATES.

S. SEAL ALL ABANDONED FLOOR PENETRATIONS IN A MANNER ACCEPTABLE TO THE OWNER.

- T. DISCONNECT ABANDONED CIRCUITS AT EXISTING PANELBOARDS AND REMOVE WIRE TO LAST REMAINING DEVICE. LABEL ALL ABANDONED CIRCUIT BREAKERS "SPARE"
- U. PROVIDE WEATHERPROOF CAPS ON ABANDONED CONDUITS PENETRATING THE ROOF. REPAIR ROOFING DAMAGED BY REMOVAL OF EXISTING ELECTRICAL EQUIPMENT.
- V. PROVIDE NEW TYPEWRITTEN DIRECTORIES FOR RE-USED PANELBOARDS THAT ARE ALTERED AS PART OF THE DEMOLITION.
- W. EXISTING CIRCUITS THAT ARE REMOVED AND NOT RE-USED SHALL BE IDENTIFIED ON THE PANEL DIRECTORIES AS "SPARE".
- X. THE CONTRACTOR SHALL PROVIDE CIRCUIT NUMBERS AND LOADS FOR ALL EXISTING REMAINING EQUIPMENT. PRIOR TO RECONNECTION, REASSIGN CIRCUITS AS REQUIRED TO BALANCE LOADS EVENLY ACROSS PHASES WHEN RECONNECTED. PROVIDE COMPLETE

"AS-BUILTS" DRAWINGS.

GENERAL NOTES

- . ALL WORK SHALL COMPLY WITH THE LATEST EDITION OF THE CALIFORNIA ELECTRICAL CODE AND ALL OTHER APPLICABLE FEDERAL AND STATE. WHERE THE CONSTRUCTION DOCUMENTS INDICATE MORE RESTRICTIVE REQUIREMENTS, THE CONSTRUCTION DOCUMENTS SHALL GOVERN BUT THE CONSTRUCTION DOCUMENTS SHALL NOT BE INTERPRETED AS AUTHORITY TO VIOLATE ANY CODE OR REGULATION.
- 2. ALL MATERIALS AND EQUIPMENT SHALL BE NEW AND SHALL BEAR THE UNDERWRITERS' LABEL (UL) AND SHALL BE INSTALLED IN THE MANNER FOR WHICH THEY ARE DESIGNED AND APPROVED.
- 3. THE CONTRACTOR SHALL NOT BORE, NOTCH OR IN ANY WAY CUT INTO ANY STRUCTURAL MEMBER WITHOUT WRITTEN APPROVAL FROM THE ARCHITECT OR STRUCTURAL ENGINEER.

SHEET INDEX

E-001

E-012

E-022

GENERAL NOTES, LEGEND, ABBREVIATIONS AND SHEET INDEX ENLARGED SITE PLAN BASEMENT DEMOLITION PLAN DEMOLITION FLOOR PLANS

AGENCY APPROVAL DSA# 03-124690

IDENTIFICATION STAMP DIV. OF THE STATE ARCHITEC

REVIEWED FOR

SS 🗹 FLS 🗹 ACS 🗌

APP: 03-124690 INC:

DATE: 04/01/2025

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<u>AQUATICS ENGINEER</u> COUNSILMAN-HUNSAKER 12851 Manchester Road, Suite 120 St. Louis, MO 63131 TEL (314) 894-1245

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PROJECT OWNER & TITLE KERN COMMUNITY COLLEGE **DISTRICT** 1801 Panorama Dr. Bakersfield, CA 93305

Bakersfield College Pool Buildings and **Site Demolition**

GENERAL NOTES, LEGEND, ABBREVIATIONS

AND SHEET INDEX JOB NUMBER: 23024.01 DRAWN BY: XX

SHEET NO.

ISSUED: SEPTEMBER 9, 2025

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802 EAST COTA STREET, SUITE A SANTA BARBARA, CA 93103 TEL (805) 963-1955

CONSULTANTS

CIVIL ENGINEER BLAIR, CHURCH, & FLYNN 451 Clovis Avenue Clovis, CA 93612 TEL (559) 326-1400

PLUMBING ENGINEER P2S INC. 5000 East Spring Street, Suite 800 Long Beach, CA 90815 TEL (562) 497-2999

MECHANICAL ENGINEER P2S INC. 5000 East Spring Street, Suite 800 Long Beach, CA 90815 TEL (562) 497-2999

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P2S INC. 5000 East Spring Street, Suite 800 Long Beach, CA 90815

TEL (562) 497-2999

AQUATICS ENGINEER COUNSILMAN-HUNSAKER 12851 Manchester Road, Suite 120 St. Louis, MO 63131 TEL (314) 894-1245

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REVISIONS

DATE DESCRIPTION

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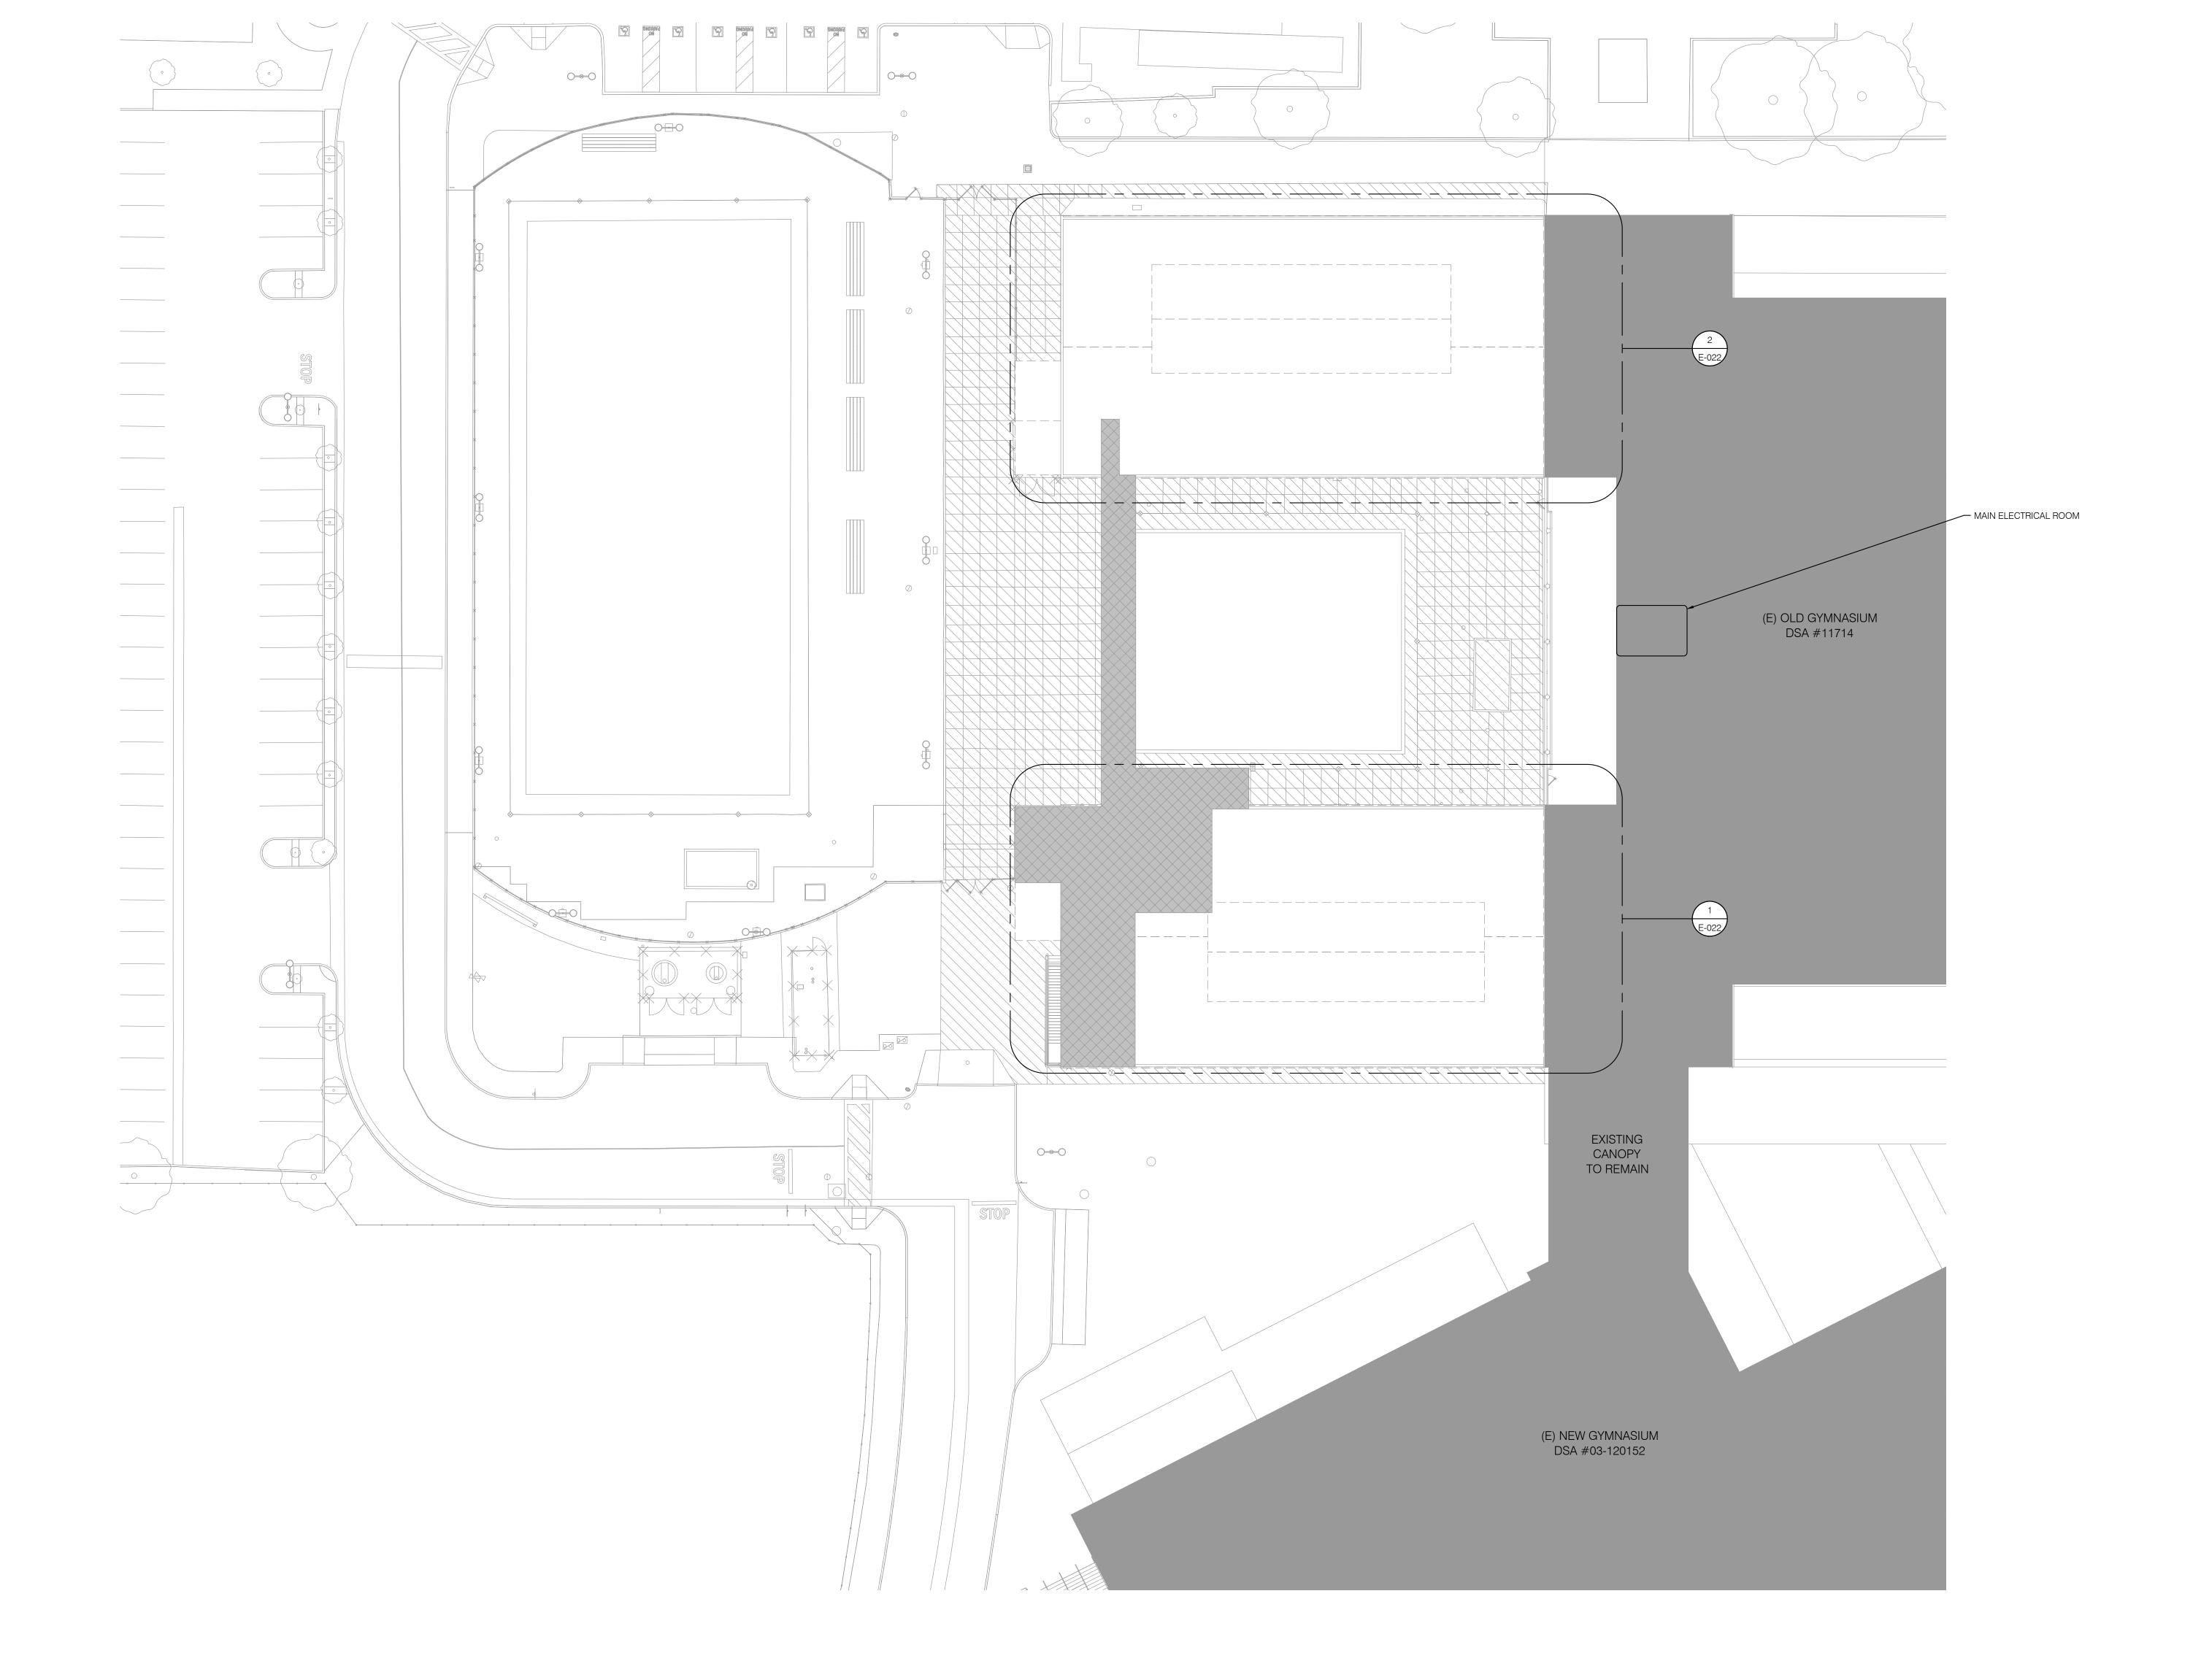
PROJECT OWNER & TITLE

KERN COMMUNITY COLLEGE **DISTRICT** 1801 Panorama Dr. Bakersfield, CA 93305

Bakersfield College Pool Buildings and **Site Demolition**

ENLARGED SITE PLAN

DRAWN BY: XX JOB NUMBER: 23024.01



NOTES

•<u>1</u>

DISCONNECT AND REMOVE ALL MECHANICAL, ELECTRICAL AND PLUMBING SYSTEMS IN BASEMENT

AGENCY APPROVAL <u>DSA#</u> 03-124690

IDENTIFICATION STAMP DIV. OF THE STATE ARCHITECT

APP: 03-124690 INC:

REVIEWED FOR

SS ☑ FLS ☑ ACS □

DATE: 04/01/2025

802 EAST COTA STREET, SUITE A SANTA BARBARA, CA 93103 TEL (805) 963-1955

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BLAIR, CHURCH, & FLYNN
451 Clovis Avenue
Clovis, CA 93612
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A Q U A T I C S E N G I N E E R COUNSILMAN-HUNSAKER 12851 Manchester Road, Suite 120 St. Louis, MO 63131 TEL (314) 894-1245

ARCHITECT STAMP

CONSULTANT STAMP

PROFESSION
PROFESSIO

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RERN COMMUNITY
COLLEGE
DISTRICT
1801 Panorama Dr.
Bakersfield, CA 93305

Bakersfield College Pool Buildings and Site Demolition

SHEET TITLE

BASEMENT DEMOLITION PLAN

DRAWN BY: XX

F-021

JOB NUMBER: 23024.01

SCALE: 1/8" = 1'-0"

DISCONNECT AND REMOVE ALL MECHANICAL, ELECTRICAL AND PLUMBING SYSTEMS IN BUILDING U.O.N.

IDENTIFICATION STAMP DIV. OF THE STATE ARCHITECT APP: 03-124690 INC: REVIEWED FOR SS 🗹 FLS 🗹 ACS 🗆

AGENCY APPROVAL <u>DSA#</u> 03-124690

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TEL (562) 497-2999

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REVISIONS DESCRIPTION


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PROJECT OWNER & TITLE KERN COMMUNITY COLLEGE **DISTRICT** 1801 Panorama Dr. Bakersfield, CA 93305

Bakersfield College Pool Buildings and Site Demolition

DEMOLITION FLOOR PLANS

DRAWN BY: XX JOB NUMBER: 23024.01

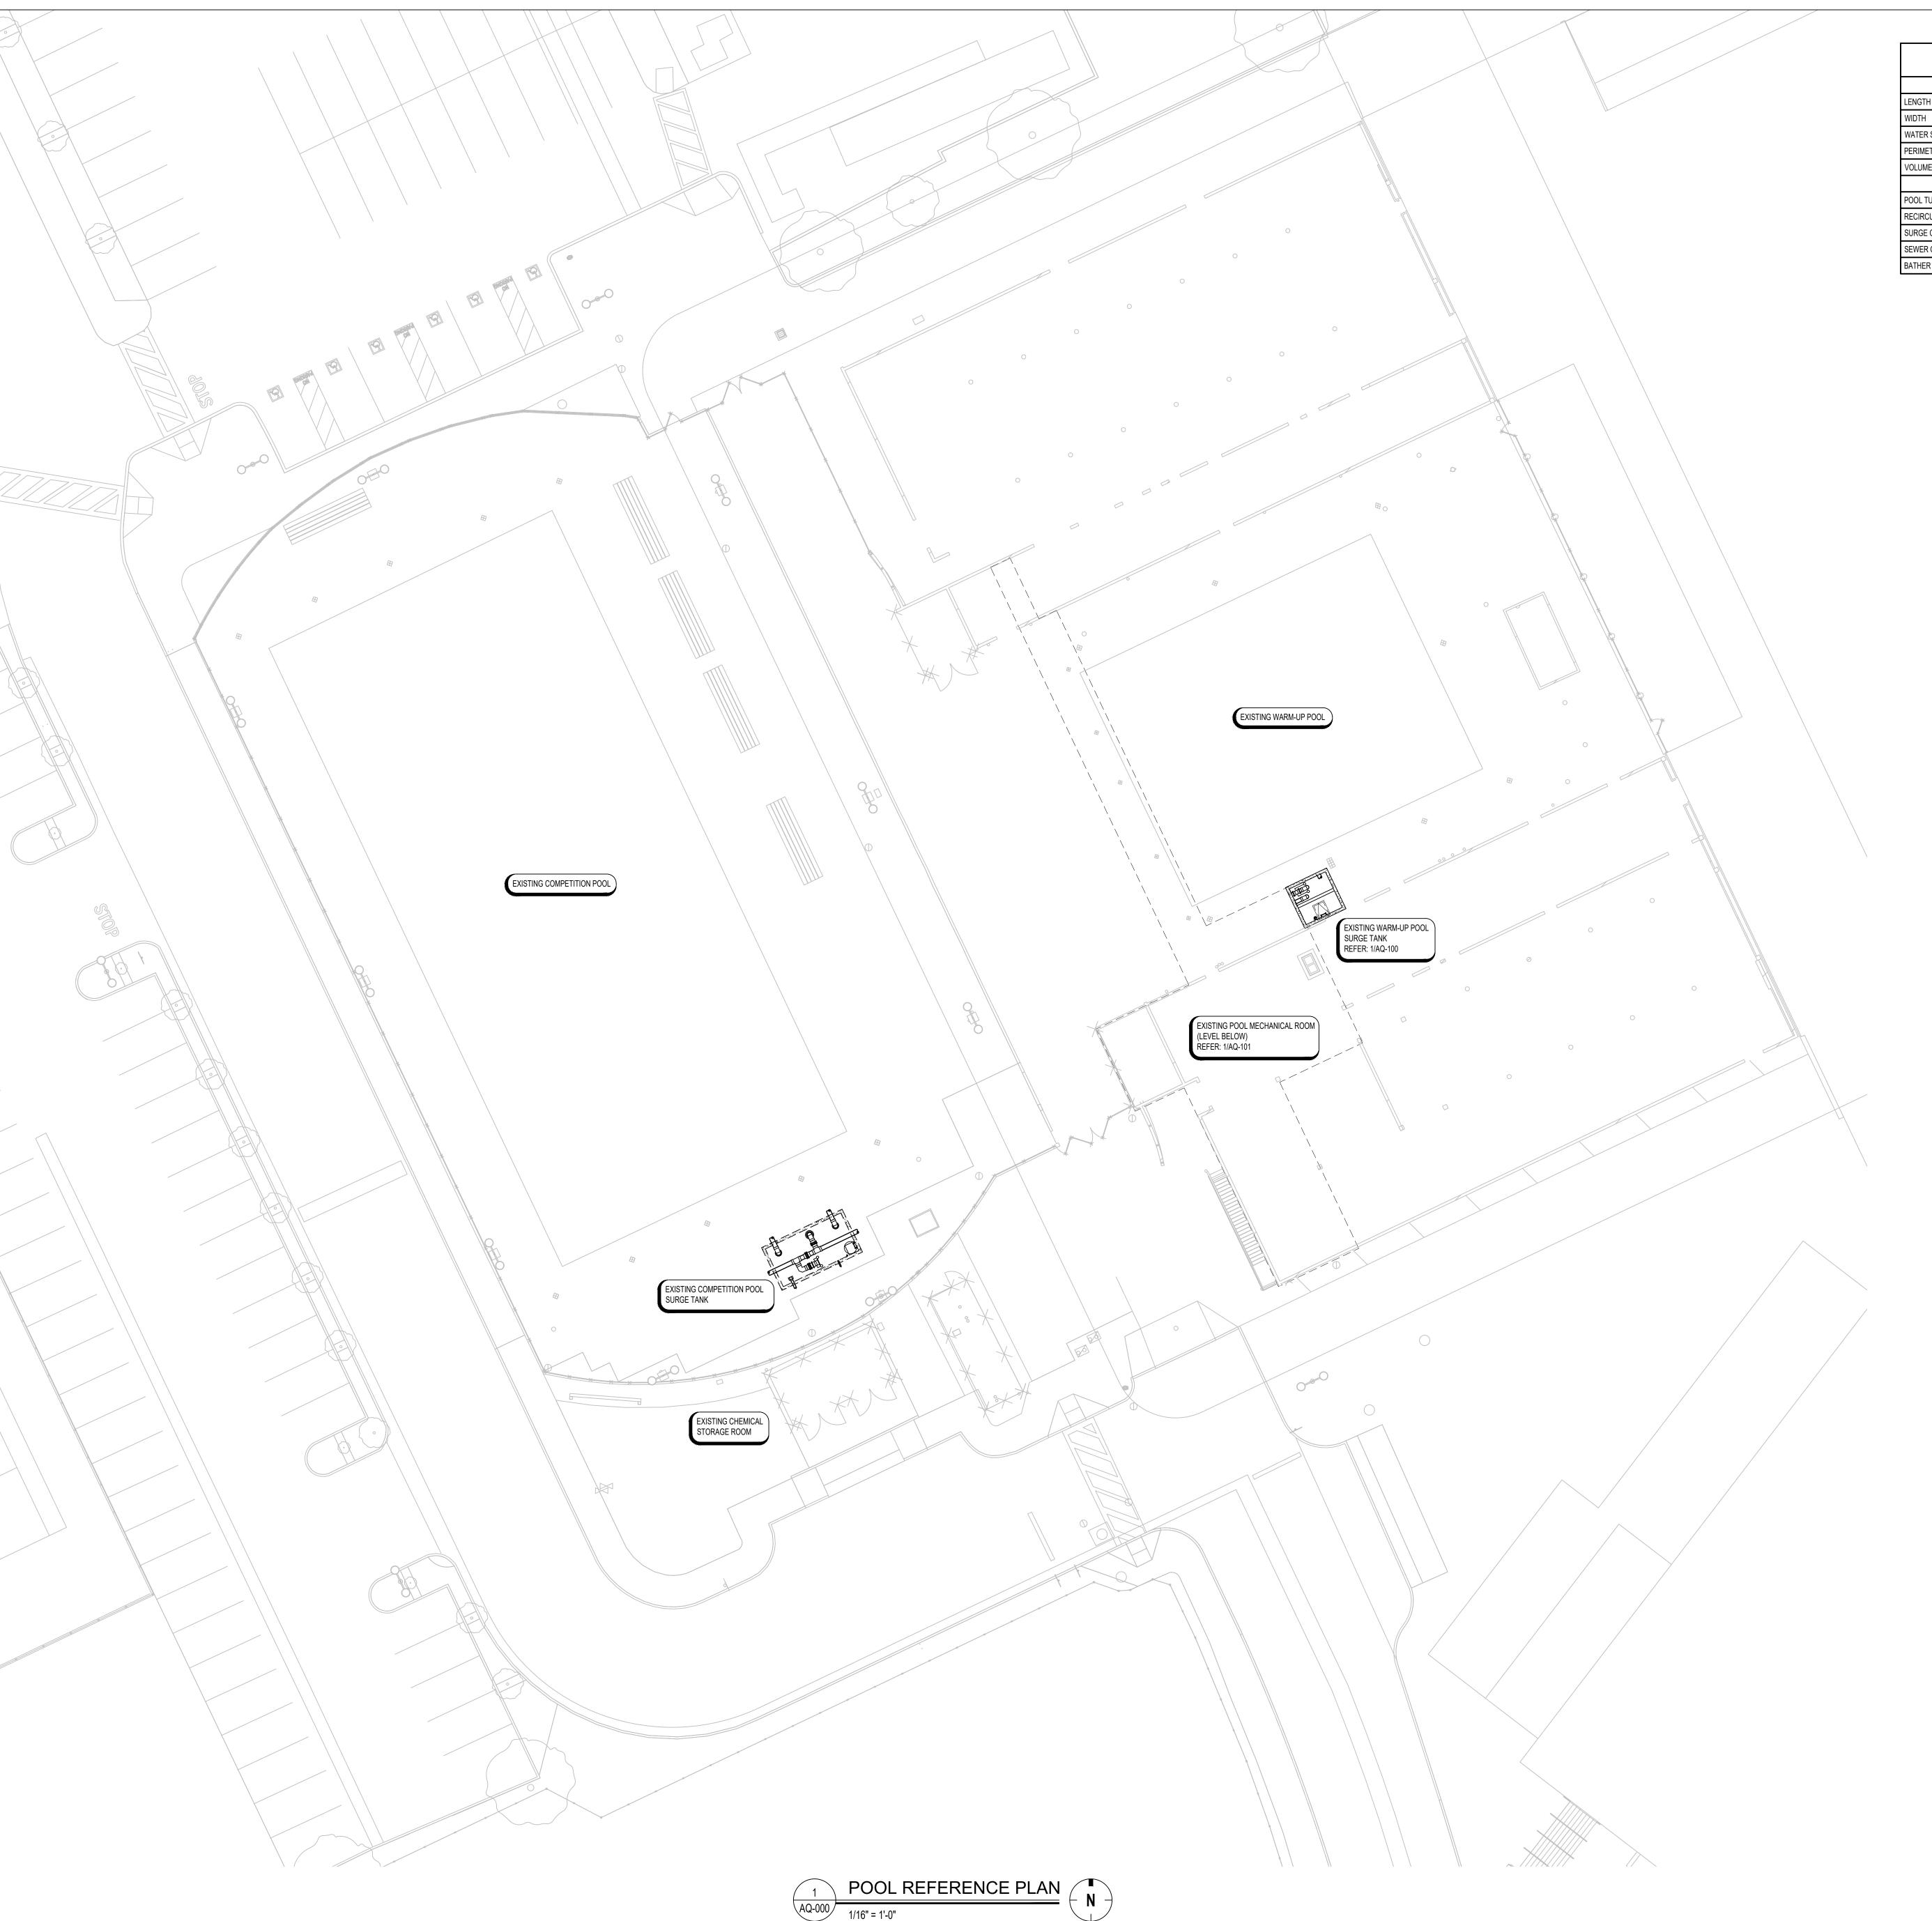

ISSUED: SEPTEMBER 9, 2025

EXISTING POOLS DESIGN DATA

EXIOTINO 1 GOLO BLOIGIT BY TIT				
	UNITS	COMPETITION POOL [50M]	WARM-UP POOL [25YD	
LENGTH	FT.	164'-1 1/2"	75'-1"	
WIDTH	FT.	75'-1"	60'-0"	
WATER SURFACE AREA	SQ. FT.	12,309	4,505	
PERIMETER	FT.	478	270	
VOLUME	GALLONS	643,900	152,091	
RECIRCULATIO	N SYSTEM			
POOL TURNOVER RATE	HOURS	6.00	4.86	
RECIRCULATION RATE	GPM	1,788	522	
SURGE CAPACITY	GALLONS	14,457	5,236	
SEWER CAPACITY	GPM	REFER TO PLUMBING	REFER TO PLUMBING	
BATHER LOAD	PERSONS	492	300	

GENERAL POOL NOTES

- 1. DENOTES WATER DEPTH FROM WATER LEVEL.
- 2. TYPICAL POOL DIMENSIONS SHOWN ARE FROM INSIDE FINISHED POOL WALL.
 3. DEPTH MARKERS AND WARNING SIGNS ARE SHOWN IN APPROXIMATE LOCATIONS. DEPTH MARKERS AND WARNING SIGNS MUST NOT EXCEED 25'-0" APART FROM EACH OTHER, AND MUST BE PLACED AT EVEN FOOT INTERVALS PER LOCAL CODE.
- SLIP RESISTANT DECK FINISH REQUIRED. REFER TO ARCHITECT.

REFER TO PLUMBING FOR DECK DRAINS AND HOSE BIBBS.

- ALL SURFACE WATER MUST DRAIN AWAY FROM THE POOL.
- . REFER TO ELECTRICAL FOR GFI OUTLETS ON POOL DECK.
- ELECTRICAL INSPECTOR MUST APPROVE INSTALLATION OF BONDING GRID FOR POOL REINFORCING AND ALL POOL EMBEDS PRIOR TO PLACEMENT OF
- 9. NO GROUND WATER MUST BE ALLOWED TO RISE ABOVE ANY PORTION OF THE
- POOL BOTTOM DURING CONSTRUCTION.

 ALL POOL REINFORCING STEEL, METAL FITTINGS, EQUIPMENT WITHIN 5'-0" OF
- POOL EDGE AND ANY METAL PARTS OF POOL EQUIPMENT IN CONTACT WITH POOL RECIRCULATION SYSTEM MUST BE BONDED PER NEC 680.
- 11. IT IS RECOMMEND THAT THE EXISTING WARM-UP BE WATER TESTED USING EXISTING POOL WATER PRIOR TO SYSTEM DRAINING IN ACCORDANCE WITH THE HYDROSTATIC TIGHTNESS TESTING STATED IN THE AMERICAN CONCRETE INSTITUTE (ACI) 350.1-10 SECTION 2.

SHEET	DESCRIPTION
AQ-000	POOL REFERENCE PLAN
AQ-100	POOL SITE DEMOLITION PLAN
AQ-101	POOL MECHANICAL ROOM DEMOLITION PLAN

AGENCY APPROVAL <u>DSA#</u> 03-124690

IDENTIFICATION STAMP DIV. OF THE STATE ARCHITECT APP: 03-124690 INC:

REVIEWED FOR SS FLS ACS ACS DATE: 04/01/2025

802 EAST COTA STREET, SUITE A SANTA BARBARA, CA 93103 TEL (805) 963-1955

CONSULTANTS

CIVIL ENGINEER
BLAIR, CHURCH, & FLYNN
451 Clovis Avenue
Clovis, CA 93612
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AQUATICS ENGINEER
COUNSILMAN-HUNSAKER
12851 Manchester Road, Suite 120
St. Louis, MO 63131
TEL (314) 894-1245

CHITECT STAMP	CONSULTANT STAM
	PROFESSIONAL ENGRAPE J. NO. 32290

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PROJECT OWNER & TITLE

KERN COMMUNITY COLLEGE

DISTRICT

DISTRICT 1801 Panorama Dr. Bakersfield, CA 93305

Bakersfield College -Pool Building and Site Demolition

HEET TITLE

POOL REFERENCE PLAN

DRAWN BY: PET JOB NUMBER: 23024.01

AQ-000

MARCH 27, 2025

RENOVATION NOTES

- DOCUMENTS BEFORE PROCEEDING WITH DEMOLITION. CONTRACTOR TO SURVEY EXISTING CONDITIONS AND CORRELATE WITH
- UNLESS OTHERWISE INDICATED, DEMOLITION WASTE BECOMES PROPERTY OF THE CONTRACTOR.
- EXCEPT FOR ITEMS OR MATERIALS INDICATED TO BE RECYCLED, REUSED, SALVAGED, REINSTALLED, OR OTHERWISE INDICATED TO REMAIN OWNER'S PROPERTY, REMOVE DEMOLISHED MATERIALS FROM PROJECT SITE AND LEGALLY DISPOSE OF THEM. OWNER HAS THE FIRST RIGHT OF REFUSAL ON ALL DEMOLITION MATERIALS.
- IMMEDIATELY NOTIFY THE OWNER AND ENGINEER.
- MAINTAIN EXISTING UTILITIES TO REMAIN IN SERVICE AND PROTECT THEM AGAINST DAMAGE DURING DEMOLITION OPERATIONS. REFER TO OTHER TRADES FOR COORDINATION.
- ELECTRICIAN MUST VERIFY EXISTING BOND GRID. ALL NEW EMBEDS AND MECHANICAL EQUIPMENT MUST BE BONDED PER NEC ARTICLE 680.
- ALL EXISTING BELOW GRADE POOL PIPING SYSTEMS MUST BE HYDROSTATICALLY (WATER) PRESSURE TESTED FOR LEAKS BEFORE THE START OF CONSTRUCTION TO VERIFY WATER TIGHTNESS. PNEUMATIC (AIR) TESTING IS NOT PERMITTED. REPORT TEST RESULTS TO THE ENGINEER TO REVIEW. REFER TO THE SWIMMING POOL SPECIFICATION FOR TESTING
- PROTECT ALL EXISTING POOL FINISHES, GUTTERS, MAIN DRAINS, AND ANY
- ALL EXISTING BELOW GRADE PIPING MUST BE PROTECTED DURING
- THE CONTRACTOR MUST BE RESPONSIBLE FOR CONTINUOUSLY MONITORING GROUNDWATER LEVELS ON THE SITE DURING ANY AND ALL PERIODS WHEN THE SWIMMING POOL IS NOT FULL OF WATER. PROTECTION OF THE EXISTING POOL STRUCTURE FROM DAMAGE DUE TO HYDROSTATIC PRESSURE IS THE

POOL SITE DEMOLITION KEYNOTES

COORDINATE ALL DEMOLITION PLANS WITH ARCHITECT AND CONSTRUCTION DOCUMENTS PRIOR TO DEMOLITION

REFER TO AS-BUILT PLANS FOR CONNECTION POINTS FOR EXISTING MAIN TANK & MECHANICAL ROOM

CONNECTION POINT FOR NEW GUTTER DROPOUT PIPE BACK TO NEW SURGE

EXISTING POOL DECK ANCHORS/MARKERS ARE ALL TO BE REMOVED/REPLACED IN KIND, REFER TO RENOVATION PLANS.

EXISTING WARM-UP POOL SURGE TANK TO BE ABANDONED & DEMOLISHED REFER TO ARCHITECTURAL & AS-BUILT PLANS

XISTING UNDERWATER POOL LIGHTING AND CONDUITS TO REMAIN (10 IGHTS). REFER TO AS-BUILT DRAWINGS & ELECTRICAL PLANS. CONFIRM FINAL POOL LIGHTING JUNCTION BOXES, CONTROLS/SWITCHES, AND POWER LOCATIONS. REFER TO ELECTRICAL.CONTROLS CANNOT BE ACCESSIBLE TO

GENERAL POOL DEMOLITION AND

COORDINATE ALL DEMOLITION PLANS AND WORK WITH ARCHITECT AND CONSTRUCTION DOCUMENTS PRIOR TO THE START OF DEMOLITION.

REVIEW RECORD DOCUMENTS OF EXISTING CONSTRUCTION PROVIDED BY THE OWNER. NEITHER THE OWNER NOR ENGINEER MAKES ANY GUARANTEE THAT THE EXISTING CONDITIONS REFLECT THOSE INDICATED IN THE RECORD DOCUMENTS. CONTRACTOR TO PROVIDE NOTIFICATION OF ANY DISCREPANCIES BETWEEN EXISTING CONDITIONS AND THE CONTRACT

REQUIREMENTS INDICATED IN THE CONTRACT DOCUMENTS TO DETERMINE THE EXTENT OF DEMOLITION REQUIRED. CONTRACTOR TO RECORD EXISTING CONDITIONS WITH DETAILED PRECONSTRUCTION PHOTOGRAPHS.

IF HAZARDOUS MATERIALS ARE ENCOUNTERED, DO NOT DISTURB.

INDICATE RECEIPT AND ACCEPTANCE OF ANY HAZARDOUS WASTES BY A LANDFILL FACILITY LICENSED TO ACCEPT SUCH HAZARDOUS WASTES.

OTHER POOL RELATED APPURTENANCES DURING CONSTRUCTION.

CONSTRUCTION. REFER TO PIPING SCHEMATICS FOR SPECIFIC PIPING RUNS TO BE REPLACED/RELOCATED AS A PART OF THE RENOVATION.

SOLE RESPONSIBILITY OF THE CONTRACTOR.

. CONTRACTOR TO PROVIDE AND EXECUTE APPROVED DUST CONTROL PLAN.

CLEAN ADJACENT STRUCTURES AND IMPROVEMENTS OF DUST, DIRT, AND DEBRIS FOLLOWING DEMOLITION OPERATIONS. CONTRACTOR TO RETURN ADJACENT AREAS TO CONDITION EXISTING BEFORE THE START OF DEMOLITION OPERATIONS.

DRAIN AND GUTTER DROPOUT PIPES FOR CONTINUATION TO NEW SURGE REFER TO AS-BUILT PLANS AND SAWCUT/REMOVE DECK TO LOCATE

EXISTING POOL DECK EQUIPMENT IS TO REMAIN AND BE STORED ON SITE.

AGENCY APPROVAL DSA# 03-124689

IDENTIFICATION STAMP DIV. OF THE STATE ARCHITEC APP: 03-124690 INC: REVIEWED FOR SS ☑ FLS ☑ ACS □

802 EAST COTA STREET, SUITE A SANTA BARBARA, CA 93103 TEL (805) 963-1955

CONSULTANTS

TEL (559) 326-1400

CIVIL ENGINEER BLAIR, CHURCH, & FLYNN 451 Clovis Avenue Clovis, CA 93612

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<u>AQUATICS ENGINEER</u> COUNSILMAN-HUNSAKER 12851 Manchester Road, Suite 120 St. Louis, MO 63131 TEL (314) 894-1245

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PROJECT OWNER & TITLE KERN COMMUNITY COLLEGE DISTRICT

1801 Panorama Dr. Bakersfield, CA 93305

Bakersfield College -**Pool Building and Site Demolition**

POOL SITE DEMOLITION PLAN

DRAWN BY: PET JOB NUMBER: 23024.01

RENOVATION NOTES

THE REMOVAL/DEMO OF EXISTING EQUIPMENT FROM THE BASEMENT IS PART OF A SEPARATE PROJECT AND NOT INCLUDED IN THE SCOPE OF WORK FOR THIS PROJECT

- COORDINATE ALL DEMOLITION PLANS AND WORK WITH ARCHITECT AND CONSTRUCTION DOCUMENTS PRIOR TO THE START OF DEMOLITION. REVIEW RECORD DOCUMENTS OF EXISTING CONSTRUCTION PROVIDED BY
- THE OWNER. NEITHER THE OWNER NOR ENGINEER MAKES ANY GUARANTEE THAT THE EXISTING CONDITIONS REFLECT THOSE INDICATED IN THE RECORD DOCUMENTS. CONTRACTOR TO PROVIDE NOTIFICATION OF ANY DISCREPANCIES BETWEEN EXISTING CONDITIONS AND THE CONTRACT
- CONTRACTOR TO SURVEY EXISTING CONDITIONS AND CORRELATE WITH REQUIREMENTS INDICATED IN THE CONTRACT DOCUMENTS TO DETERMINE THE EXTENT OF DEMOLITION REQUIRED. CONTRACTOR TO RECORD EXISTING CONDITIONS WITH DETAILED PRECONSTRUCTION PHOTOGRAPHS.
- UNLESS OTHERWISE INDICATED, DEMOLITION WASTE BECOMES PROPERTY OF THE CONTRACTOR.
- MAINTAIN EXISTING UTILITIES TO REMAIN IN SERVICE AND PROTECT THEM AGAINST DAMAGE DURING DEMOLITION OPERATIONS. REFER TO OTHER
- MECHANICAL EQUIPMENT MUST BE BONDED PER NEC ARTICLE 680. ALL EXISTING BELOW GRADE POOL PIPING SYSTEMS MUST BE
- HYDROSTATICALLY (WATER) PRESSURE TESTED FOR LEAKS BEFORE THE START OF CONSTRUCTION TO VERIFY WATER TIGHTNESS. PNEUMATIC (AIR) TESTING IS NOT PERMITTED. REPORT TEST RESULTS TO THE ENGINEER TO REVIEW. REFER TO THE SWIMMING POOL SPECIFICATION FOR TESTING REQUIREMENTS.
- PROTECT ALL EXISTING POOL FINISHES, GUTTERS, MAIN DRAINS, AND ANY OTHER POOL RELATED APPURTENANCES DURING CONSTRUCTION.
- ALL EXISTING BELOW GRADE PIPING MUST BE PROTECTED DURING CONSTRUCTION. REFER TO PIPING SCHEMATICS FOR SPECIFIC PIPING RUNS TO BE REPLACED/RELOCATED AS A PART OF THE RENOVATION. THE CONTRACTOR MUST BE RESPONSIBLE FOR CONTINUOUSLY MONITORING
- GROUNDWATER LEVELS ON THE SITE DURING ANY AND ALL PERIODS WHEN THE SWIMMING POOL IS NOT FULL OF WATER. PROTECTION OF THE EXISTING POOL STRUCTURE FROM DAMAGE DUE TO HYDROSTATIC PRESSURE IS THE SOLE RESPONSIBILITY OF THE CONTRACTOR.
- 5. CLEAN ADJACENT STRUCTURES AND IMPROVEMENTS OF DUST, DIRT, AND DEBRIS FOLLOWING DEMOLITION OPERATIONS. CONTRACTOR TO RETURN ADJACENT AREAS TO CONDITION EXISTING BEFORE THE START OF DEMOLITION OPERATIONS.

POOL MECHANICAL DEMOLITION KEYNOTES

DOCUMENTS PRIOR TO DEMOLITION

REMOVE EXISTING WARM-UP POOL RECIRCULATION PUMP AND ITS

REMOVE EXISTING COMPETITION POOL RECIRCULATION PUMP AND ITS

REMOVE COMPETITION POOL FILTERS & PIPING MANIFOLD. PROTECT FOR RELOCATION & REUSE.

RELOCATION & REUSE.

/ENTING, AND GAS/ELECTRIC CONNECTIONS FOR RELOCATION & REUSE.

D8 REMOVE EXISTING COMPETITION POOL CHEMICAL CONTROLLER. PROTECT FOR RELOCATION & REUSE.

GENERAL POOL DEMOLITION AND *FOR REFERENCE ONLY*

- DOCUMENTS BEFORE PROCEEDING WITH DEMOLITION.

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- TRADES FOR COORDINATION. ELECTRICIAN MUST VERIFY EXISTING BOND GRID. ALL NEW EMBEDS AND

- 4. CONTRACTOR TO PROVIDE AND EXECUTE APPROVED DUST CONTROL PLAN.

COORDINATE ALL DEMOLITION PLANS WITH ARCHITECT AND CONSTRUCTION

ORRESPONDING MOTOR STARTER/VFD.

ORRESPONDING MOTOR STARTER/VFD.

REMOVE WARM-UP POOL FILTERS & PIPING MANIFOLD. PROTECT FOR

REMOVE EXISTING COMPETITION POOL HEATERS. DISCONNECT PIPING,

REMOVE EXISTING WARM-UP POOL HEATER. DISCONNECT PIPING, VENTING, AND GAS/ELECTRIC CONNECTIONS. CONTRACTOR TO COORDINATE DISPOSAL

REMOVE EXISTING WARM-UP POOL CHEMICAL CONTROLLER. PROTECT FOR RELOCATION & REUSE.

AGENCY APPROVAL DSA# 03-124690

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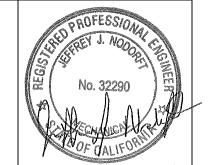
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PROJECT OWNER & TITLE KERN COMMUNITY COLLEGE DISTRICT

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Bakersfield College -**Pool Building and Site Demolition**

POOL MECHANICAL ROOM DEMO. PLAN

DRAWN BY: PET JOB NUMBER: 23024.01